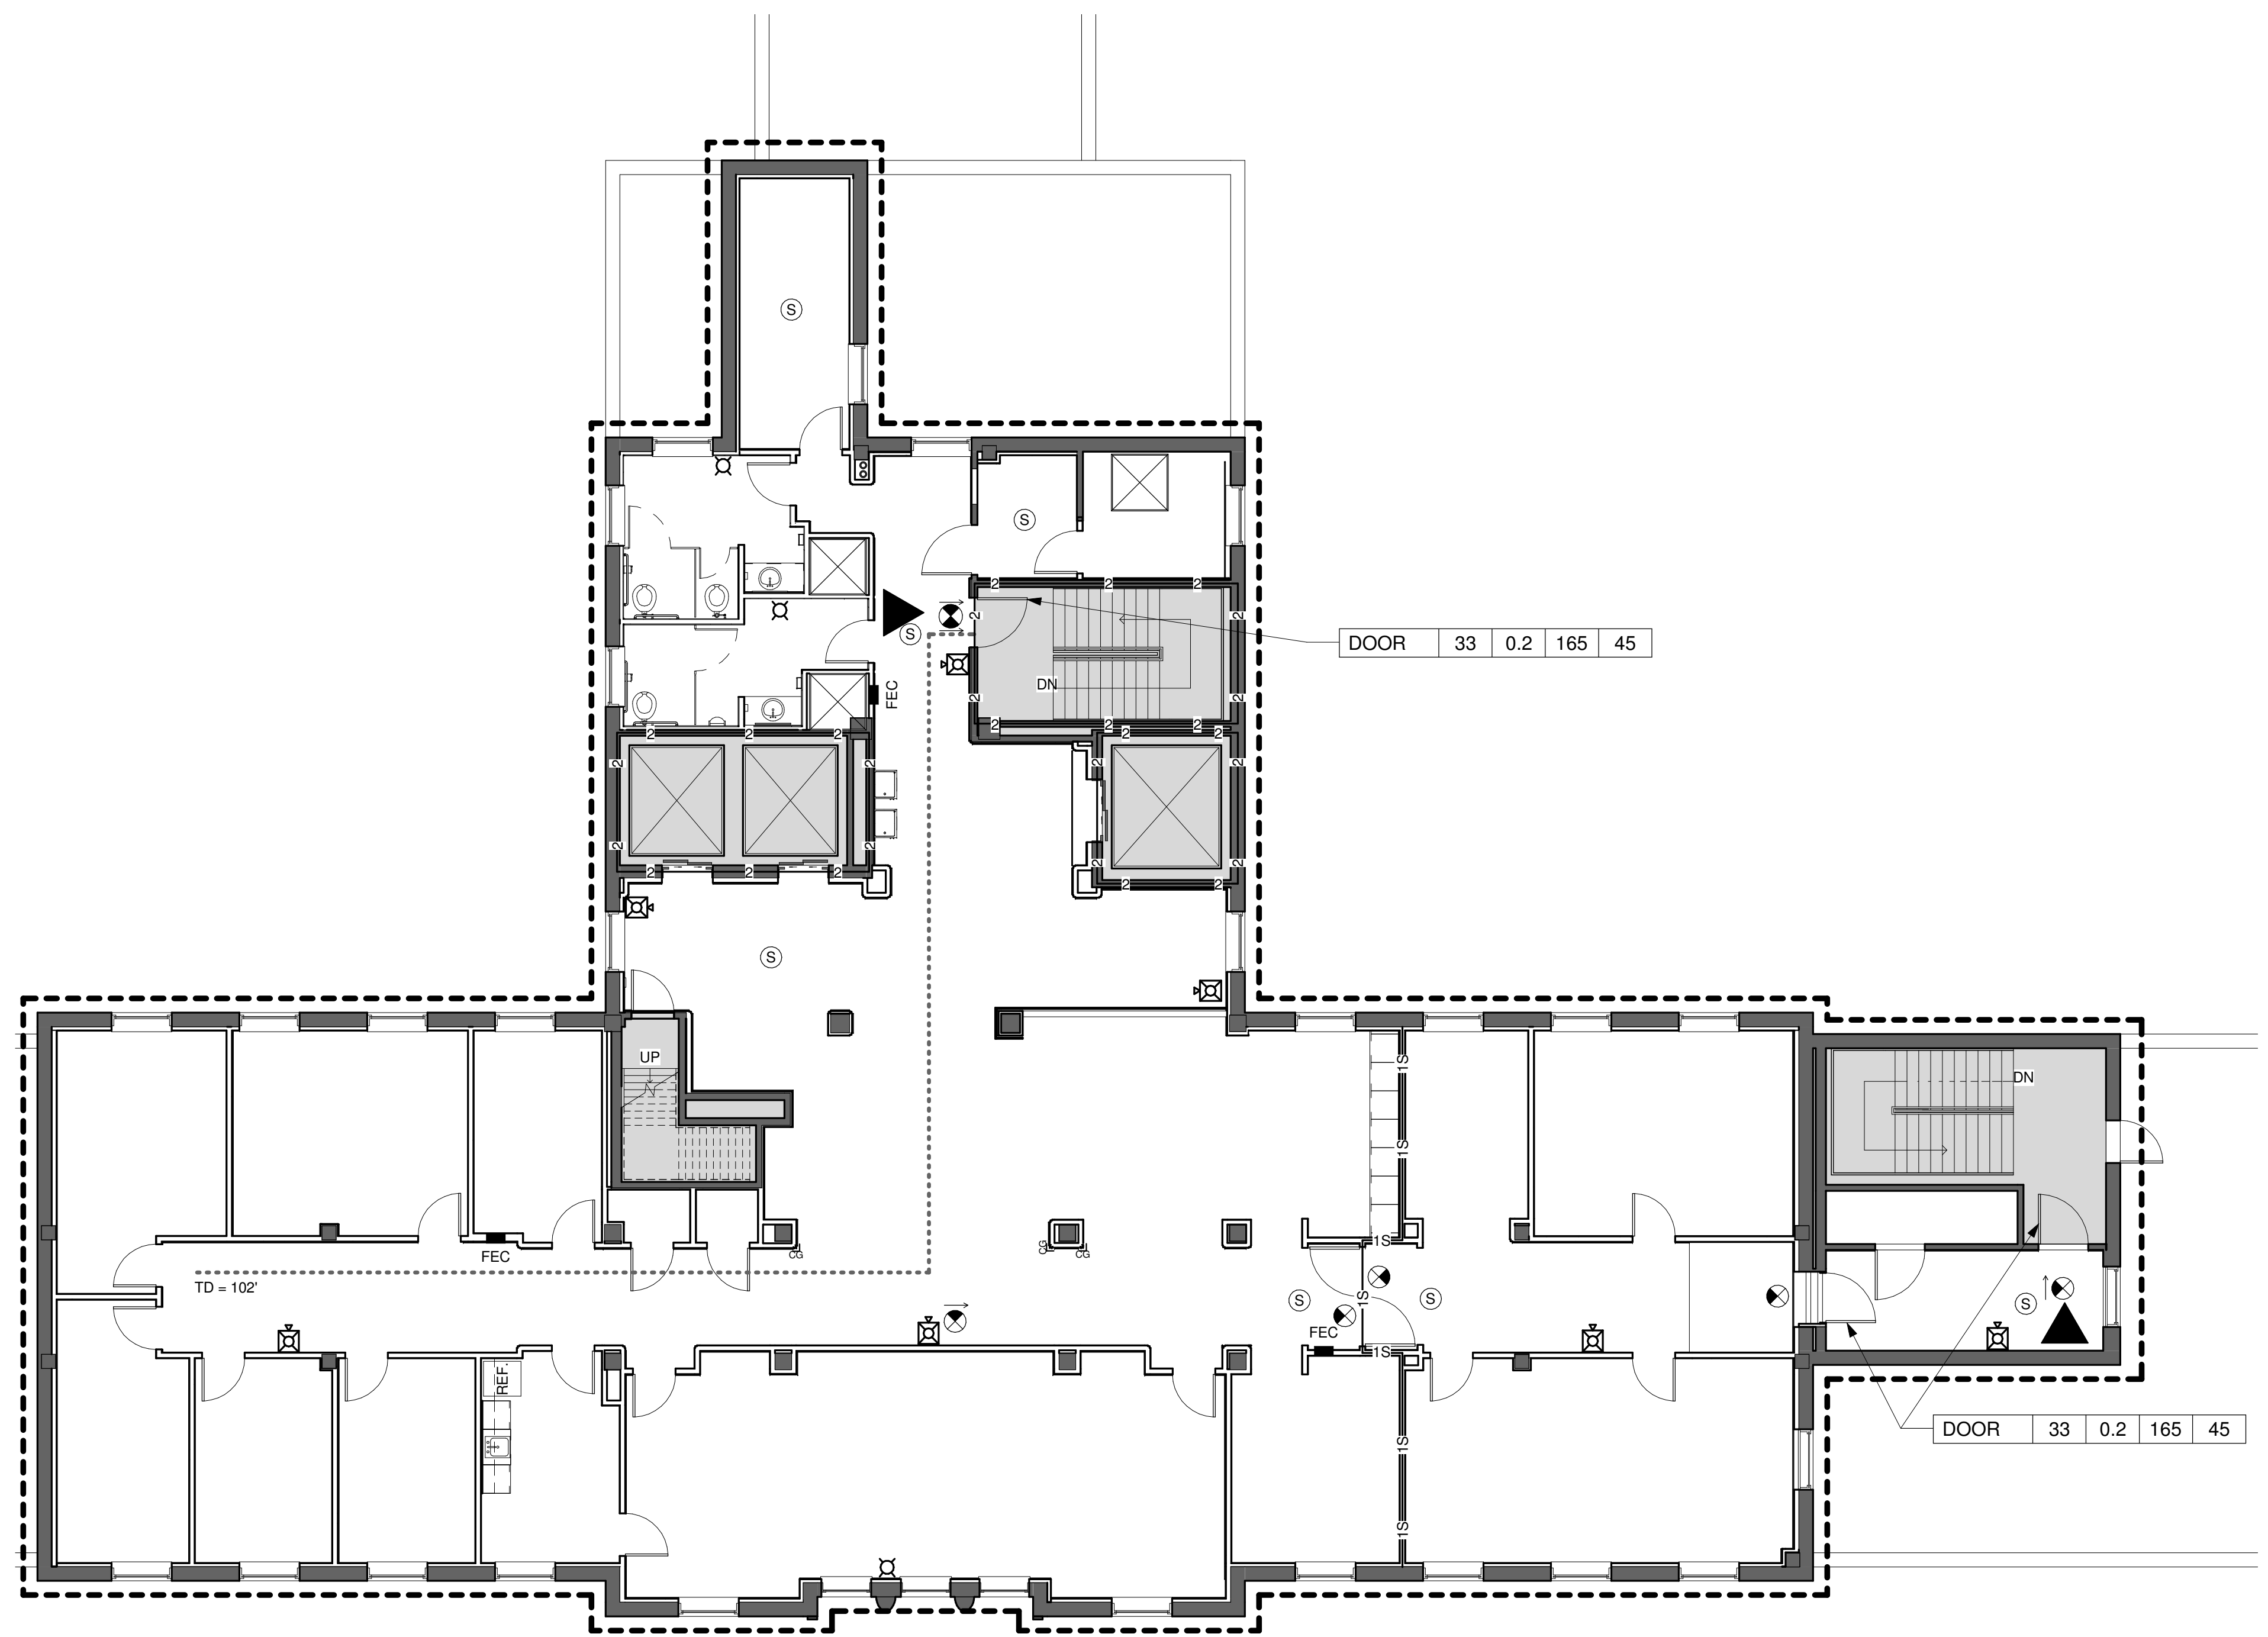

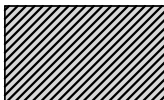







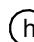





AB	CLASS A DOOR	COL	COLUMN	FLR SK	FLOOR SINK	LS	LUMP SUM	PO	PURCHASE ORDER POST OFFICE	STRL	STRUCTURAL STEEL
A/C	AIR CONDITION	COM	COMMON	FLUR	FLOOR	LT	LIGHT	POLY	POLYETHYLENE (PLASTIC)	SUB	SUBSTITUTE
A/C UNIT	AIR CONDITIONING UNIT	COMB	COMBINATION, COMBINED	FLUR FIX	FLUORESCENT FIXTURE	LT GA	LIGHT GAGE	PR	PAIR	SURF	SURFACE
AA	ARCHITECT/ENGINEER	COMM	COMMUNICATION	FM	FIRE MOUNTING	LT MT	LIGHT MOUNTING	SUSP	SUSPENSION	SUSP	SUSPENDED CEILING
AAMA	AMERICAN ARCHITECTURAL MANUFACTURERS ASSOCIATION	COMP	COMPONENT	FM-G	FACTORY MUTUAL GLOBAL	LTNG	LIGHTNING	PREFAB	PREFABRICATE	SUSP CLG	SUSPENDED CEILING
AB	AGGREGATE BASE COURSE	CONC	CONCRETE	FO	FINISHED OPENING	LVD	LOUVER	PREFIN	PREFINISHED	SW	SHEET VINYL
ABC	AGGREGATE BASE COURSE	CONC FLR	CONCRETE FLOOR	FOC	FACE OF CONCRETE OR FACE OF CURB	LVR	LOUVER	PREP	PREPARATION	SWDR	SWING DOOR
AC	ASBESTOS CEMENT OR ASPHALTIC CONCRETE	COND	CONDENSER OR CONDITION	FOM	FACE OF MASONRY	LWC	LIGHTWEIGHT CONCRETE	PRESS	PRESSURE	SYM	SYMBOL
ACI	AMERICAN CONCRETE INSTITUTE	CONF	CONFERENCE	FOS	FACE OF SLAB OR FACE OF STUD	LWIC	LIGHTWEIGHT INSULATING CONCRETE	PREV	PREVENTION	SYNTH	SYNTHETIC
ACM	ASBESTOS CONTAINING MATERIAL	CONN	CONNECT	FOUNT	FOUNTAIN	LVR	LAYER	PRKG	PARKING	YS	SYSTEM
ACP	ACRYLIC GLAZING	CONSTR	CONSTRUCTION	FOW	FACE OF WALL	MACH	MACHINE	PRMLD	PREMOLDED	T&G	TONGUE AND GROOVE
ACS DR	ACCESS DOOR	CONT	CONTAINER	FP	FIRE PROTECTION OR FIREPROOF	MACH RM	MACHINE ROOM	PROJ	PROJECT	T&M	TIME AND MATERIALS
ACS FLR	ACCESS FLOOR	CONTR	CONTRACTOR	FS	FEET PER MINUTE	MAINT	MAINTENANCE	PSF	POUNDS PER SQUARE FOOT	TB	THROUGH BOLT OR TOWEL BAR
ACS PNL	ACCESS PANEL	COORD	COORDINATE	FR	FRAMING	MAINT	MAINTENANCE	MAN	MANUAL	TB	THROUGH BOLT OR TOWEL BAR
ACST	ACOUSTIC	CORR	CORROSION	FR	FRAMING	MAINT	MAINTENANCE	MAN	MANUAL	TB	THROUGH BOLT OR TOWEL BAR
ACT	ACOUSTICAL CEILING TILE	CPM	CRITICAL PATH METHOD	FR	FRAMING	MAINT	MAINTENANCE	MAN	MANUAL	TB	THROUGH BOLT OR TOWEL BAR
AD	AREA DRAIN	CPHS	COMPRESSIBLE	FREQ	FREQUENCY	MAINT	MAINTENANCE	MAN	MANUAL	TB	THROUGH BOLT OR TOWEL BAR
ADA	AMERICANS WITH DISABILITIES ACT	CRT	CARPET	FRG	FIBER REINFORCED POLYESTER OR FIBERGLASS REINFORCED PLASTIC	MAINT	MAINTENANCE	MAN	MANUAL	TB	THROUGH BOLT OR TOWEL BAR
ADC	AUTOMATIC DOOR CLOSER	CRS	COLD ROLLED STEEL	FRP	FIBER REINFORCED POLYESTER OR FIBERGLASS REINFORCED PLASTIC	MAINT	MAINTENANCE	MAN	MANUAL	TB	THROUGH BOLT OR TOWEL BAR
ADDL	ADDITIONAL	CSGI	CONCRETE REINFORCING STEEL INSTITUTE	FRZ	FIBERGLASS REINFORCED PLASTIC	MAINT	MAINTENANCE	MAN	MANUAL	TB	THROUGH BOLT OR TOWEL BAR
ADDN	ADDITION	CSG	CONCRETE REINFORCING STEEL INSTITUTE	FRZ	FIBERGLASS REINFORCED PLASTIC	MAINT	MAINTENANCE	MAN	MANUAL	TB	THROUGH BOLT OR TOWEL BAR
ADH	ADHESIVE	CSS	CASING	FS	FEDERAL SPECIFICATION	MAINT	MAINTENANCE	MAN	MANUAL	TB	THROUGH BOLT OR TOWEL BAR
ADJ	ADJACENT, ADJOINING, OR ADJUSTABLE	CSI	CONSTRUCTION SPECIFICATIONS INSTITUTE	FS	FEDERAL SPECIFICATION	MAINT	MAINTENANCE	MAN	MANUAL	TB	THROUGH BOLT OR TOWEL BAR
ADMN	ADMINISTRATION	CSMT	CASEMENT	FS	FEDERAL SPECIFICATION	MAINT	MAINTENANCE	MAN	MANUAL	TB	THROUGH BOLT OR TOWEL BAR
ADB	AUTOMATIC DOOR BOTTOM	CSW	CASEWORK	FS	FEDERAL SPECIFICATION	MAINT	MAINTENANCE	MAN	MANUAL	TB	THROUGH BOLT OR TOWEL BAR
AFC	ABOVE FINISHED COUNTER	CSW	CASEWORK	FS	FEDERAL SPECIFICATION	MAINT	MAINTENANCE	MAN	MANUAL	TB	THROUGH BOLT OR TOWEL BAR
AF	ABOVE FINISHED FLOOR	CSW	CASEWORK	FS	FEDERAL SPECIFICATION	MAINT	MAINTENANCE	MAN	MANUAL	TB	THROUGH BOLT OR TOWEL BAR
AFG	ABOVE FINISHED GRADE	CSW	CASEWORK	FS	FEDERAL SPECIFICATION	MAINT	MAINTENANCE	MAN	MANUAL	TB	THROUGH BOLT OR TOWEL BAR
AFS	ABOVE FINISHED SLAB	CSW	CASEWORK	FS	FEDERAL SPECIFICATION	MAINT	MAINTENANCE	MAN	MANUAL	TB	THROUGH BOLT OR TOWEL BAR
AG	AMERICAN GAS ASSOCIATION	CSW	CASEWORK	FS	FEDERAL SPECIFICATION	MAINT	MAINTENANCE	MAN	MANUAL	TB	THROUGH BOLT OR TOWEL BAR
AGC	ASSOCIATED GENERAL CONTRACTORS	CSW	CASEWORK	FS	FEDERAL SPECIFICATION	MAINT	MAINTENANCE	MAN	MANUAL	TB	THROUGH BOLT OR TOWEL BAR
AGGR	AGGREGATE	CSW	CASEWORK	FS	FEDERAL SPECIFICATION	MAINT	MAINTENANCE	MAN	MANUAL	TB	THROUGH BOLT OR TOWEL BAR
AHJ	AUTHORITY HAVING JURISDICTION	CSW	CASEWORK	FS	FEDERAL SPECIFICATION	MAINT	MAINTENANCE	MAN	MANUAL	TB	THROUGH BOLT OR TOWEL BAR
AHR	ANCHOR	CSW	CASEWORK	FS	FEDERAL SPECIFICATION	MAINT	MAINTENANCE	MAN	MANUAL	TB	THROUGH BOLT OR TOWEL BAR
AHU	AIR HANDLING UNIT	CSW	CASEWORK	FS	FEDERAL SPECIFICATION	MAINT	MAINTENANCE	MAN	MANUAL	TB	THROUGH BOLT OR TOWEL BAR
AI	AMERICAN INSTITUTE OF ARCHITECTS	CSW	CASEWORK	FS	FEDERAL SPECIFICATION	MAINT	MAINTENANCE	MAN	MANUAL	TB	THROUGH BOLT OR TOWEL BAR
AISC	AMERICAN INSTITUTE OF STEEL CONSTRUCTION	CSW	CASEWORK	FS	FEDERAL SPECIFICATION	MAINT	MAINTENANCE	MAN	MANUAL	TB	THROUGH BOLT OR TOWEL BAR
ALT	ALTERNATE	CSW	CASEWORK	FS	FEDERAL SPECIFICATION	MAINT	MAINTENANCE	MAN	MANUAL	TB	THROUGH BOLT OR TOWEL BAR
ALT NO	ALTERNATE NUMBER	CSW	CASEWORK	FS	FEDERAL SPECIFICATION	MAINT	MAINTENANCE	MAN	MANUAL	TB	THROUGH BOLT OR TOWEL BAR
ALUM	ALUMINUM	CSW	CASEWORK	FS	FEDERAL SPECIFICATION	MAINT	MAINTENANCE	MAN	MANUAL	TB	THROUGH BOLT OR TOWEL BAR
AMF	AMPERE	D	DEPTH OR PENNY (NAIL)	CLASS D DOOR	CLASS D DOOR	MIN	MINIMUM	REC	RECEIVED	T&M	TIME AND MATERIALS
AMT	AMOUNT	D LABEL	DEPTH OR PENNY (NAIL)	CLASS D DOOR	CLASS D DOOR	MIN	MINIMUM	REC	RECEIVED	T&M	TIME AND MATERIALS
ANOD	ANODIZE	DAT	DATUM	HAZ MAT	HAZARDOUS MATERIALS	MTD	MOUNTED	RESIL	RESILIENT	UNO	UNINTERRUPTIBLE POWER SUPPLY
ANR	AMERICAN NATIONAL STANDARDS INSTITUTE	DB	DOUBLE	HAZ MAT	HAZARDOUS MATERIALS	MTD	MOUNTED	RESIL	RESILIENT	UNO	UNINTERRUPTIBLE POWER SUPPLY
ANT	ANTENNA	DBL	DOUBLE	HAZ MAT	HAZARDOUS MATERIALS	MTD	MOUNTED	RESIL	RESILIENT	UNO	UNINTERRUPTIBLE POWER SUPPLY
APA	AMERICAN PLYWOOD ASSOCIATION	DBL GLZ	DOUBLE GLAZE	HAZ MAT	HAZARDOUS MATERIALS	MTD	MOUNTED	RESIL	RESILIENT	UNO	UNINTERRUPTIBLE POWER SUPPLY
APPD	APPROVED	DEG	DEGREE	HAZ MAT	HAZARDOUS MATERIALS	MTD	MOUNTED	RESIL	RESILIENT	UNO	UNINTERRUPTIBLE POWER SUPPLY
APPROX	APPROXIMATE	DEG	DEGREE	HAZ MAT	HAZARDOUS MATERIALS	MTD	MOUNTED	RESIL	RESILIENT	UNO	UNINTERRUPTIBLE POWER SUPPLY
APT	APARTMENT	DEL	DELETE	HAZ MAT	HAZARDOUS MATERIALS	MTD	MOUNTED	RESIL	RESILIENT	UNO	UNINTERRUPTIBLE POWER SUPPLY
AR	ARCHITECT	DEMO	DEMOLITION	HAZ MAT	HAZARDOUS MATERIALS	MTD	MOUNTED	RESIL	RESILIENT	UNO	UNINTERRUPTIBLE POWER SUPPLY
ARCH	ARCHITECT	DEMO	DEMOLITION	HAZ MAT	HAZARDOUS MATERIALS	MTD	MOUNTED	RESIL	RESILIENT	UNO	UNINTERRUPTIBLE POWER SUPPLY
ASB	ASBESTOS	DET	DETAIL	HAZ MAT	HAZARDOUS MATERIALS	MTD	MOUNTED	RESIL	RESILIENT	UNO	UNINTERRUPTIBLE POWER SUPPLY
ASL	ARCHITECT'S SUPPLEMENTAL INSTRUCTION	DET	DETAIL	HAZ MAT	HAZARDOUS MATERIALS	MTD	MOUNTED	RESIL	RESILIENT	UNO	UNINTERRUPTIBLE POWER SUPPLY
ASPH	ASPHALT	DIAG	DIAGONAL	HAZ MAT	HAZARDOUS MATERIALS	MTD	MOUNTED	RESIL	RESILIENT	UNO	UNINTERRUPTIBLE POWER SUPPLY
ASTM	AMERICAN SOCIETY FOR TESTING AND MATERIALS	DIAG	DIAGONAL	HAZ MAT	HAZARDOUS MATERIALS	MTD	MOUNTED	RESIL	RESILIENT	UNO	UNINTERRUPTIBLE POWER SUPPLY
ATM	ATTACHMENT	DISP	DIRECTION	HAZ MAT	HAZARDOUS MATERIALS	MTD	MOUNTED	RESIL	RESILIENT	UNO	UNINTERRUPTIBLE POWER SUPPLY
ATS	AUTOMATIC TELLER MACHINE	DISP	DIRECTION	HAZ MAT	HAZARDOUS MATERIALS	MTD	MOUNTED	RESIL	RESILIENT	UNO	UNINTERRUPTIBLE POWER SUPPLY
AUTO	AUTOMATIC	DIV	DIVIDE OR DIVISION	HAZ MAT	HAZARDOUS MATERIALS	MTD	MOUNTED	RESIL	RESILIENT	UNO	UNINTERRUPTIBLE POWER SUPPLY
AV	AUDIO VISUAL	DL	DEAD LOAD	HAZ MAT	HAZARDOUS MATERIALS	MTD	MOUNTED	RESIL	RESILIENT	UNO	UNINTERRUPTIBLE POWER SUPPLY
AVE	AVENUE	DOC	DOCUMENT	HAZ MAT	HAZARDOUS MATERIALS	MTD	MOUNTED	RESIL	RESILIENT	UNO	UNINTERRUPTIBLE POWER SUPPLY
AVG	AVERAGE	DOUG FIR	DOUGLAS FIR	HAZ MAT	HAZARDOUS MATERIALS	MTD	MOUNTED	RESIL	RESILIENT	UNO	UNINTERRUPTIBLE POWER SUPPLY
AW	ACID WASTE	DR	DOOR	HAZ MAT	HAZARDOUS MATERIALS	MTD	MOUNTED	RESIL	RESILIENT	UNO	UNINTERRUPTIBLE POWER SUPPLY
AWI	ARCHITECTURAL WOODWORKING INSTITUTE	DR CL	DOOR CLOSER	HAZ MAT	HAZARDOUS MATERIALS	MTD	MOUNTED	RESIL	RESILIENT	UNO	UNINTERRUPTIBLE POWER SUPPLY
AWPA	AMERICAN WOOD PRESERVERS' ASSOCIATION	DR	DOOR	HAZ MAT	HAZARDOUS MATERIALS	MTD	MOUNTED	RESIL	RESILIENT	UNO	UNINTERRUPTIBLE POWER SUPPLY
AWT	AMERICAN WELDING SOCIETY	DR OPNG	DOOR OPENING	HAZ MAT	HAZARDOUS MATERIALS	MTD	MOUNTED	RESIL	RESILIENT	UNO	UNINTERRUPTIBLE POWER SUPPLY
AWT	ACOUSTICAL WALL TREATMENT	DS	DOWNSPOUT	HAZ MAT	HAZARDOUS MATERIALS	MTD	MOUNTED	RESIL	RESILIENT	UNO	UNINTERRUPTIBLE POWER SUPPLY
B LABEL	CLASS B DOOR	DW	DISHWASHER	HAZ MAT	HAZARDOUS MATERIALS	MTD	MOUNTED	RESIL	RESILIENT	UNO	UNINTERRUPTIBLE POWER SUPPLY
B PL	BASE PLATE	DWG	DRAWING	HAZ MAT	HAZARDOUS MATERIALS	MTD	MOUNTED	RESIL	RESILIENT	UNO	UNINTERRUPTIBLE POWER SUPPLY
BALC	BALCONY	DWTR	DRAINAGE	HAZ MAT	HAZARDOUS MATERIALS	MTD	MOUNTED	RESIL	RESILIENT	UNO	UNINTERRUPTIBLE POWER SUPPLY
BAT	BATTEN	E	EAST	HAZ MAT	HAZARDOUS MATERIALS	MTD	MOUNTED	RESIL	RESILIENT	UNO	UNINTERRUPTIBLE POWER SUPPLY
BB	BULLETIN BOARD	E LABEL	EAST	HAZ MAT	HAZARDOUS MATERIALS	MTD	MOUNTED	RESIL	RESILIENT	UNO	UNINTERRUPTIBLE POWER SUPPLY
BD	BOARD	EACH	EACH	HAZ MAT	HAZARDOUS MATERIALS	MTD	MOUNTED	RESIL	RESILIENT	UNO	UNINTERRUPTIBLE POWER SUPPLY
BD FT	BOARD FEET (FOOT)	EFP	EFFICIENCY	HAZ MAT	HAZARDOUS MATERIALS	MTD	MOUNTED	RESIL	RESILIENT	UNO	UNINTERRUPTIBLE POWER SUPPLY
BEV	BEVEL	ELEV	ELEVATION	HAZ MAT	HAZARDOUS MATERIALS	MTD	MOUNTED	RESIL	RESILIENT	UNO	UNINTERRUPTIBLE POWER SUPPLY
BHMA	BUILDERS' HARDWARE MANUFACTURERS' ASSOCIATION	EIPS	EXTERIOR INSULATION AND FINISH SYSTEM	HAZ MAT	HAZARDOUS MATERIALS	MTD	MOUNTED	RESIL	RESILIENT	UNO	UNINTERRUPTIBLE POWER SUPPLY
BI FLD DR	BIFOLDING DOORS	EJ	EXPANSION JOINT	HAZ MAT	HAZARDOUS MATERIALS	MTD	MOUNTED	RESIL	RESILIENT	UNO	UNINTERRUPTIBLE POWER SUPPLY
BITUM	BITUMEN	ELEV	ELEVATION	HAZ MAT	HAZARDOUS MATERIALS	MTD	MOUNTED	RESIL	RESILIENT	UNO	UNINTERRUPTIBLE POWER SUPPLY
BKG	BACKING	ELEV	ELEVATION	HAZ MAT	HAZARDOUS MATERIALS	MTD	MOUNTED	RESIL	RESILIENT	UNO	UNINTERRUPTIBLE POWER SUPPLY
BLD	BUILD	ELEV	ELEVATION	HAZ MAT	HAZARDOUS MATERIALS	MTD	MOUNTED	RESIL	RESILIENT	UNO	UNINTERRUPTIBLE POWER SUPPLY
BLDG	BUILDING	ELEV	ELEVATION	HAZ MAT	HAZARDOUS MATERIALS	MTD	MOUNTED	RESIL	RESILIENT	UNO	UNINTERRUPTIBLE POWER SUPPLY
BLKT	BLANKET	ELEV	ELEVATION	HAZ MAT	HAZARDOUS MATERIALS	MTD	MOUNTED	RESIL	RESILIENT	UNO	UNINTERRUPTIBLE POWER SUPPLY
BLVD	BOULEVARD	ELEV	ELEVATION	HAZ MAT	HAZARDOUS MATERIALS	MTD	MOUNTED	RESIL	RESILIENT	UNO	UNINTERRUPTIBLE POWER SUPPLY
BM	BENCH MARK	ELEV	ELEVATION	HAZ MAT	HAZARDOUS MATERIALS	MTD	MOUNTED	RESIL	RESILIENT	UNO	UNINTERRUPTIBLE POWER SUPPLY
BOT	BOTTOM	ELEV	ELEVATION	HAZ MAT	HAZARDOUS MATERIALS	MTD	MOUNTED	RESIL	RESILIENT	UNO	UNINTERRUPTIBLE POWER SUPPLY
BR	BEDROOM	ELEV	ELEVATION	HAZ MAT	HAZARDOUS MATERIALS	MTD	MOUNTED	RESIL	RESILIENT	UNO	UNINTERRUPTIBLE POWER SUPPLY
BRG	BRIDGING	ELEV	ELEVATION	HAZ MAT	HAZARDOUS MATERIALS	MTD	MOUNTED	RESIL	RESILIENT	UNO	UNINTERRUPTIBLE POWER SUPPLY
BRDG	BRIDGING	ELEV	ELEVATION	HAZ MAT	HAZARDOUS MATERIALS	MTD	MOUNTED	RESIL	RESILIENT	UNO	UNINTERRUPTIBLE POWER SUPPLY
BRDG JST	BRIDGING JOIST	ELEV	ELEVATION	HAZ MAT	HAZARDOUS MATERIALS	MTD	MOUNTED	RESIL	RESILIENT	UNO	UNINTERRUPTIBLE POWER SUPPLY
BRG	BRIDGING	ELEV	ELEVATION	HAZ MAT	HAZARDOUS MATERIALS	MTD	MOUNTED	RESIL	RESILIENT	UNO	UNINTERRUPTIBLE POWER SUPPLY
BRG PL	BRIDGING PLATE	ELEV	ELEVATION	HAZ MAT	HAZARDOUS MATERIALS	MTD	MOUNTED	RESIL	RESILIENT	UNO	UNINTERRUPTIBLE POWER SUPPLY
BRKT	BRACKET	ELEV	ELEVATION	HAZ MAT	HAZARDOUS MATERIALS	MTD	MOUNTED	RESIL	RESILIENT	UNO	UNINTERRUPTIBLE POWER SUPPLY
BSMT	BASEMENT	ELEV	ELEVATION	HAZ MAT	HAZARDOUS MATERIALS	MTD	MOUNTED	RESIL	RESILIENT	UNO	UNINTERRUPTIBLE POWER SUPPLY
BTWN	BETWEEN	ELEV	ELEVATION	HAZ MAT	HAZARDOUS MATERIALS	MTD	MOUNTED	RESIL	RESILIENT	UNO	UNINTERRUPTIBLE POWER SUPPLY
BUR	BUILT-UP ROOFING	ELEV	ELEVATION	HAZ MAT	HAZARDOUS MATERIALS	MTD	MOUNTED	RESIL	RESILIENT	UNO	UNINTERRUPTIBLE POWER SUPPLY
C	CELSIUS CHANNEL	ESCAL	ESCALATOR	HAZ MAT	HAZARDOUS MATERIALS	MTD	MOUNTED	RESIL	RESILIENT	UNO	UNINTERRUPTIBLE POWER SUPPLY
C	CHANNEL	ESCAL	ESCALATOR	HAZ MAT	HAZARDOUS MATERIALS	MTD	MOUNTED	RESIL	RESILIENT	UNO	UNINTERRUPTIBLE POWER SUPPLY
C CONC	CAST CONCRETE	ESCAL	ESCALATOR	HAZ MAT	HAZARDOUS MATERIALS	MTD	MOUNTED	RESIL	RESILIENT	UNO	UNINTERRUPTIBLE POWER SUPPLY
C LABEL	CLASS C DOOR	ESCAL	ESCALATOR	HAZ MAT	HAZARDOUS MATERIALS	MTD	MOUNTED	RESIL	RESILIENT	UNO	UNINTERRUPTIBLE POWER SUPPLY
C TO C	CENTER TO CENTER	ESCAL	ESCALATOR	HAZ MAT	HAZARDOUS MATERIALS	MTD	MOUNTED	RESIL	RESILIENT	UNO	UNINTERRUPTIBLE POWER SUPPLY
CAB	CABINET	ESCAL	ESCALATOR	HAZ MAT	HAZARDOUS MATERIALS	MTD	MOUNTED	RESIL	RESILIENT	UNO	UNINTERRUPTIBLE POWER SUPPLY
CAC	CEILING ATTENUATION CLASS	ESCAL	ESCALATOR	HAZ MAT	HAZARDOUS MATERIALS	MTD	MOUNTED	RESIL	RESILIENT	UNO	UNINTERRUPTIBLE POWER SUPPLY
CB	CATCH BASIN OR CORNER BEAD	ESCAL	ESCALATOR	HAZ MAT	HAZARDOUS MATERIALS	MTD	MOUNTED	RESIL	RESILIENT	UNO	UNINTERRUPTIBLE POWER SUPPLY
CBB	CEMENTITIOUS (BACKER) BOARD	ESCAL	ESCALATOR	HAZ MAT	HAZARDOUS MATERIALS	MTD	MOUNTED	RESIL	RESILIENT	UNO	UNINTERRUPTIBLE POWER SUPPLY
CC	CUBIC CENTIMETER	ESCAL	ESCALATOR	HAZ MAT	HAZARDOUS MATERIALS	MTD	MOUNTED	RESIL	RESILIENT	UNO	UNINTERRUPTIBLE POWER SUPPLY
CCG	CLOSED CIRCUIT TELEVISION	ESCAL	ESCALATOR	HAZ MAT	HAZARDOUS MATERIALS	MTD	MOUNTED	RESIL	RESILIENT	UNO	UNINTERRUPTIBLE POWER SUPPLY
COW	COUNTERCLOCKWISE	ESCAL	ESCALATOR	HAZ MAT	HAZARDOUS MATERIALS	MTD	MOUNTED	RESIL	RESILIENT	UNO	UNINTERRUPTIBLE POWER SUPPLY
CD	CONSTRUCTION DOCUMENTS OR CONTRACT DOCUMENTS	ESCAL	ESCALATOR	HAZ MAT	HAZARDOUS MATERIALS	MTD	MOUNTED	RESIL	RESILIENT	UNO	UNINTERRUPTIBLE POWER SUPPLY
CEM	CEMENT	ESCAL	ESCALATOR	HAZ MAT	HAZARDOUS MATERIALS	MTD	MOUNTED	RESIL	RESILIENT	UNO	UNINTERRUPTIBLE POWER SUPPLY
CEM PLAS	CEMENT PLASTER	ESCAL	ESCALATOR	HAZ MAT	HAZARDOUS MATERIALS	MTD	MOUNTED	RESIL	RESILIENT	UNO	UNINTERRUPTIBLE POWER SUPPLY
CF	CONTRACTOR FURNISHED	ESCAL	ESCALATOR	HAZ MAT	HAZARDOUS MATERIALS	MTD	MOUNTED	RESIL	RESILIENT	UNO	UNINTERRUPTIBLE POWER SUPPLY
CF/CI	CONTRACTOR FURNISHED/CONTRACTOR INSTALLED	ESCAL	ESCALATOR	HAZ MAT	HAZARDOUS MATERIALS	MTD	MOUNTED	RESIL	RESILIENT	UNO	UNINTERRUPTIBLE POWER SUPPLY
CF/OI	CONTRACTOR FURNISHED/OWNER INSTALLED	ESCAL	ESCALATOR	HAZ MAT	HAZARDOUS MATERIALS	MTD	MOUNTED	RESIL	RESILIENT	UNO	UNINTERRUPTIBLE POWER SUPPLY
CFLG	COUNTERFLASHING	ESCAL	ESCALATOR	HAZ MAT	HAZARDOUS MATERIALS	MTD	MOUNTED	RESIL	RESILIENT	UNO	UNINTERRUPTIBLE POWER SUPPLY
CFM	CUBIC FEET PER MINUTE	ESCAL	ESCALATOR	HAZ MAT	HAZARDOUS MATERIALS	MTD	MOUNTED	RESIL	RESILIENT	UNO	UNINTERRUPTIBLE POWER SUPPLY
CFMF	COLD-FORMED METAL FRAMING	ESCAL	ESCALATOR	HAZ MAT	HAZARDOUS MATERIALS	MTD	MOUNTED	RESIL	RESILIENT	UNO	UNINTERRUPTIBLE POWER SUPPLY
CFS	CUBIC FEET PER SECOND	ESCAL	ESCALATOR	HAZ MAT	HAZARDOUS MATERIALS	MTD	MOUNTED	RESIL	RESILIENT	UNO	UNINTERRUPTIBLE POWER SUPPLY
CGSFU	CENTER OF GRAVITY OR CORNER GUARD	ESCAL	ESCALATOR	HAZ MAT	HAZARDOUS MATERIALS	MTD	MOUNTED	RESIL	RESILIENT	UNO	UNINTERRUPTIBLE POWER SUPPLY
CH BD	CHALKBOARD	ESCAL	ESCALATOR	HAZ MAT	HAZARDOUS MATERIALS	MTD	MOUNTED	RESIL	RESILIENT	UNO	UNINTERRUPTIBLE POWER SUPPLY
CH	CHEMICAL	ESCAL	ESCALATOR	HAZ MAT	HAZARDOUS MATERIALS	MTD	MOUNTED	RESIL	RESILIENT	UNO	UNINTERRUPTIBLE POWER SUPPLY
CHFR	CHAMFER	ESCAL	ESCALATOR	HAZ MAT	HAZARDOUS MATERIALS	MTD	MOUNTED	RESIL	RESILIENT	UNO	UNINTERRUPTIBLE POWER SUPPLY
CHK	CHECK	ESCAL	ESCALATOR	HAZ MAT	HAZARDOUS MATERIALS	MTD	MOUNTED	RESIL	RESILIENT	UNO	UNINTERRUPTIBLE POWER SUPPLY
CHL	CAST IRON	ESCAL	ESCALATOR	HAZ MAT	HAZARDOUS MATERIALS</						

BUILDING IS FULLY SPRINKLERED



1 6TH FLOOR LIFE SAFETY PLAN
SCALE: 1/8" = 1'-0"

- ### FIRE PROTECTION - SYMBOLS LEGEND:
- | | |
|---|---|
|  | AREA IN CONTRACT |
|  | 2 HOUR EXIT PASSAGE WAY / EXIT STAIR |
|  | AREA NOT IN CONTRACT |
|  | EXIT |
|  | RECESSED FIRE EXTINGUISHER CABINET AND FIRE EXTINGUISHER |
|  | DOUBLE SIDED EXIT SIGNAGE CEILING MOUNTED |
|  | DOUBLE SIDED EXIT SIGNAGE CEILING MOUNTED WITH DIRECTIONAL ARROWS |
|  | SINGLE SIDED EXIT SIGNAGE CEILING MOUNTED |
|  | SINGLE SIDED EXIT SIGNAGE CEILING MOUNTED WITH DIRECTIONAL ARROWS |
|  | CEILING MOUNTED HEAT DETECTOR |
|  | STROBE NOTIFICATION |
|  | CEILING SMOKE DETECTOR |
|  | COMBINATION VOICE EVACUATION SPEAKER / STROBE UNIT |
- TRAVEL DISTANCE
10 ± 100'
MEASURED DISTANCE

DOOR	33	0.2	165	157
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ACTUAL PEOPLE
CAPACITY PEOPLE
EXIT WIDTH
EGRESS WIDTH
EGRESS COMPONENT
- 1—1—1— ONE HOUR RATING, 45 MINUTE "C" LABEL DOORS

—1s—1s—1s— ONE HOUR RATED SMOKE BARRIER, 20 MINUTE DOORS

—2—2—2— TWO HOUR RATING, 90 MINUTE "B" LABEL DOORS

—2s—2s—2s— TWO HOUR RATED SMOKE BARRIER, 90 MINUTE DOORS

—3—3—3— THREE HOUR RATING

----- SMOKE TIGHT CORRIDOR WALL CONSTRUCTION SHALL BE SMOKE TIGHT, WALL IS NOT RATED

- A. MAINTAIN FIRE EXTINGUISHER LOCATIONS DURING CONSTRUCTION
- B. MAINTAIN RATING ON SHAFTS DURING CONSTRUCTION
- C. PATCH HOLES IN FLOOR DURING CONSTRUCTION TO MAINTAIN 2HR RATING
- D. ALL EXIT DOORS TO REMAIN UNLOCKED DURING CONSTRUCTION

INTERNATIONAL BUILDING CODE
NFPA 101 LIFE SAFETY CODE (LSC)
INTERNATIONAL MECHANICAL CODE
NATIONAL ELECTRICAL CODE
UNIFORM PLUMBING CODE
INTERNATIONAL ENERGY CONSERVATION CODE
NATIONAL FIRE CODE
FIRE PROTECTION DESIGN GUIDES, USDVA

FIRE PROTECTION SYSTEMS:
-WET-PIPE SPRINKLER SYSTEM
-FIRE ALARM NOTIFICATION SYSTEM
-AUTOMATIC SMOKE DETECTION


BUILDING CONSTRUCTION TYPE:
-TYPE IIA

**BUILDING IS
FULLY
SPRINKLERED**


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A
B
C
D
E
F

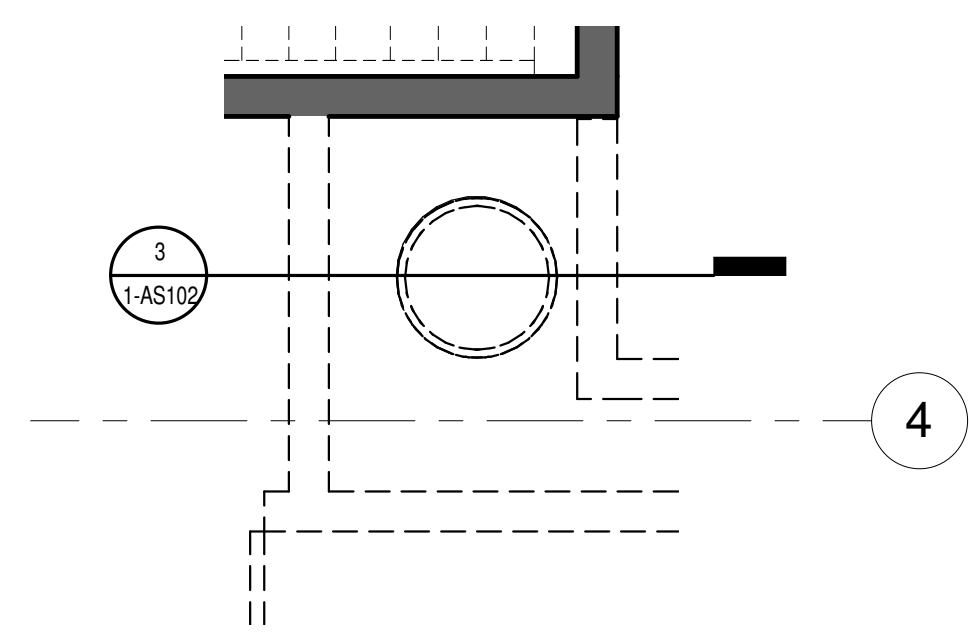
three inches = one foot
one and one half inches = one foot
one inch = one foot
three quarters inch = one foot
one half inch = one foot
three eighths inch = one foot
one quarter inch = one foot
one eighth inch = one foot



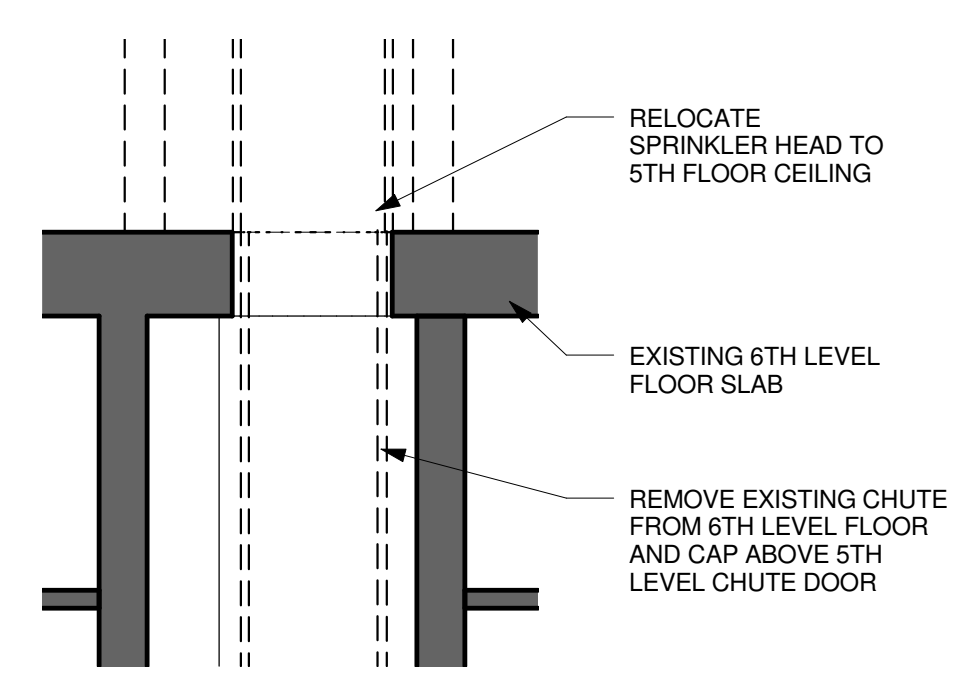2 LAUNDRY CHUTE DEMOLITION
SCALE: 1/2" = 1'-0"
RE:1 /1-AS102



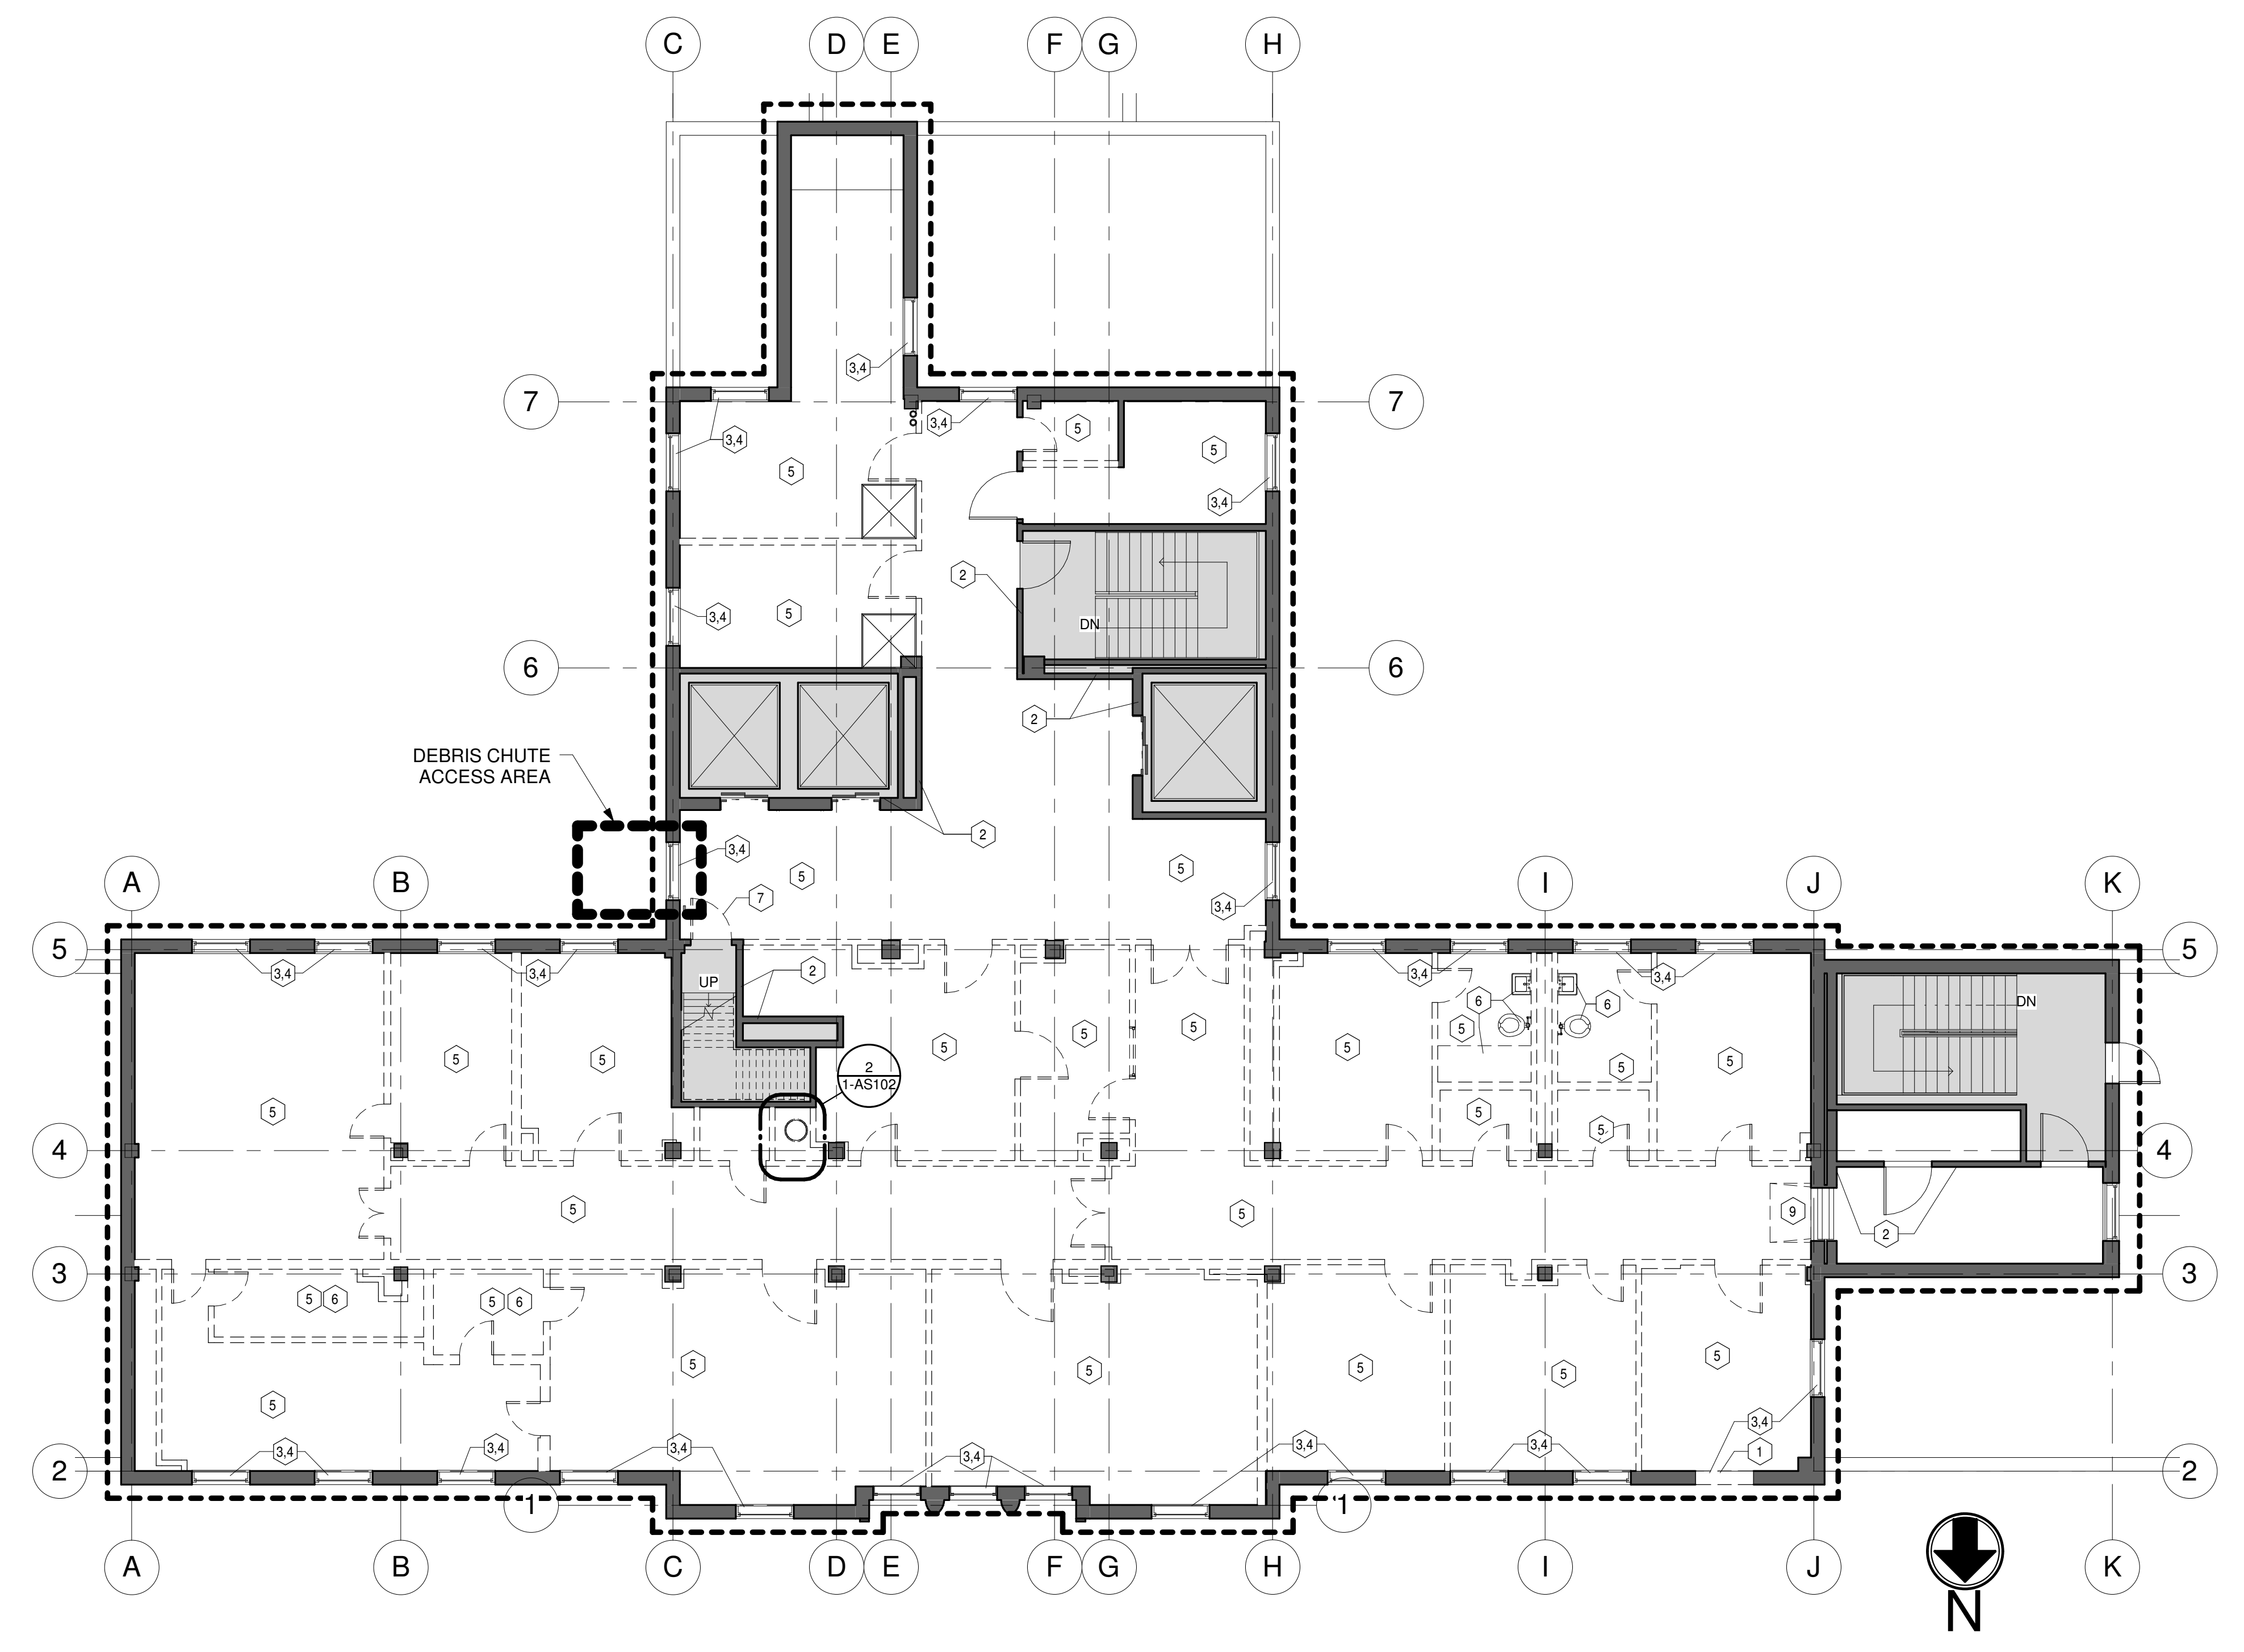3 6TH FLOOR LAUNDRY CHUTE DEMOLITION
SCALE: 1/2" = 1'-0"
RE:2 /1-AS102



1 6TH FLOOR DEMOLITION
SCALE: 1/8" = 1'-0"

GRAPHIC LEGEND

	AREA IN CONTRACT		AREA NOT IN CONTRACT
	DASHED LINE DENOTES ITEM TO BE DEMOLISHED		LINE DENOTES ITEM TO REMAIN
	EXISTING WALLS TO BE REMOVED		EXISTING WALLS TO REMAIN
	EXISTING DOOR TO BE REMOVED		EXISTING DOOR TO REMAIN
	DEMOLITION PLAN NOTE		LIMITS OF CONSTRUCTION


- GENERAL NOTES**
- VERIFY ALL DIMENSIONS AND CONDITIONS AT JOB SITE.
 - VERIFY EXACT COMPOSITION OF EXISTING WALLS TO BE REMOVED.
 - REMOVE FLOOR FINISHES, AND MASTIC INCLUDING SETTING BED IN CERAMIC TILE AREAS IF APPLICABLE.
 - REMOVE SUSPENDED CEILING ASSEMBLIES, RELATED HANGERS AND ANCHORS, OR GYPSUM BOARD/PLASTER CEILINGS WHERE NEW CEILINGS ARE INDICATED ON REFLECTED CEILING PLAN OR ROOM FINISH SCHEDULE.
 - REMOVE ALL INTERIOR AND WALL MOUNTED ITEMS IN AREAS TO BE REMODELED (REFER TO ROOM FINISH SCHEDULE) INCLUDING BUT NOT LIMITED TO, CABINETRY, EQUIPMENT, LOCKERS, TOILET PARTITIONS, SHELVING, HOOKSTRIPS, HANDRAILS, CLOSET POLES, CHALK AND TACK BOARDS, MIRRORS, WALL AND CEILING TRIM, BASE.
 - REMOVE EXISTING WALL FINISHES IN ROOMS WHERE NEW FINISHES ARE INDICATED IN THE ROOM FINISH SCHEDULE. EXISTING WALLS TO BE PREPARED AS REQUIRED TO ACCEPT NEW SCHEDULED FINISHES.
 - AT EXISTING WALLS SHOWN TO REMAIN (INCLUDING EXTERIOR WALLS). THE EXISTING COVERED TILE/ TERRAZZO BASE IS TO BE REMOVED AND INFILLED IN PREPARATION FOR NEW WALL BASE AND FINISHES TO BE INSTALLED PER THE ROOM FINISH SCHEDULE. EXISTING TERRAZZO DIVIDER STRIP TO BE GROUND DOWN OR REMOVED. SEE SHEET 1-AS503.
 - REFER TO PLUMBING HVAC AND ELECTRICAL PLANS FOR ADDITIONAL DEMOLITION ITEMS AND NOTES. COORDINATE WORK WITH PLUMBING, HVAC AND ELECTRICAL REQUIREMENTS.
 - MAINTAIN CONTINUOUS UTILITY SERVICE TO ALL SPACES IN THE BUILDING NOT AFFECTED BY THIS WORK. COORDINATE WITH OWNER ANY DISRUPTION IN SERIES REQUIRED TO PERFORM WORK OR TO MODIFY EXISTING PIPING, DUCTWORK, OR ANY ASSOCIATED EQUIPMENT.
 - ALL EXISTING ABANDONED MECHANICAL EQUIPMENT AND ALL ASSOCIATED PIPING DISCOVERED DURING DEMOLITION IS TO BE REMOVED AND DISCARDED BY CONTRACTOR.
 - REMOVE ALL COLUMN FINISHES AND UTILITIES, INCLUDING GYPSUM BOARD AND FURRINGS FROM EXISTING STRUCTURAL COLUMNS. NEW WALL FURRINGS ARE TO BE PROVIDED AT ALL COLUMNS AS PART OF NEW CONSTRUCTION WHETHER SPECIFICALLY NOTED ON FLOOR PLAN OR NOT.
 - ALL ABANDONED PIPING INCLUDING ABANDONED PNEUMATIC TUBES TO BE REMOVED AND DISCARDED BY CONTRACTOR
 - REMOVE ALL CEILINGS AND CEILING SUBSTRATE LOCATED IN PROJECT AREA INCLUDING PLASTER CEILINGS ABOVE 6TH FLOOR CEILING.
 - WALLS AND SUBSTRATE MATERIAL LOCATED AT COLUMNS TO BE REMOVED BACK TO CONCRETE COLUMN
 - DEMO TO BE COORDINATED WITH ASBESTOS ABATEMENT.

- SHEET NOTES**
- A ALL EXISTING INTERIOR WALLS, FINISHES, FLOORING, AND COMPLETE CEILINGS ASSEMBLIES TO BE REMOVED FROM 6TH FLOOR FLOOR SLAB TO THE BOTTOM OF ROOF AND PENTHOUSE FLOOR SLAB AND TO INTERIOR FINISH OF EXTERIOR/CORE WALLS AND COLUMNS.
 - B REMOVE EXISTING PLUMBING FIXTURES. SEE PLUMBING DRAWINGS FOR FULL EXTENT OF DEMOLITION.
 - C EXISTING MECHANICAL IN-WALL STEAM RADIATOR CABINETS TO REMAIN AND CONTAINING MATERIALS AND EQUIPMENT TO BE REMOVED AND DISCARDED. SUPPLY COPPER PIPE TO BE CAPPED OFF BELOW SLAB. REFERENCE ENGINEERING DRAWINGS FOR PLUMBING, ELECTRICAL, FIRE, AND MECHANICAL EQUIPMENT AND FIXTURE DEMOLITION WORK.

- KEY NOTES**
- 1 REPLACE EXISTING WINDOW GLAZING WITH CLEAR GLASS.
 - 2 EXISTING SHAFT / CHASE TO REMAIN. CONTRACTOR TO MAINTAIN FIRE RESISTANCE RATING INTEGRITY AT SHAFTS INDICATED WITH WAVE DASH LINE TYPES
 - 3 REMOVE ALL EXISTING STEAM RADIATORS. EXISTING CABINET TO REMAIN. SEE SHEET 1-AS503 FOR ADDITIONAL DEMOLITION INFORMATION.
 - 4 EXISTING WINDOW SILL TO REMAIN AND BE REFINISHED WITH NEW SOLID SURFACE VENEER.
 - 5 EXISTING ROOM WALLS TO BE DEMOLISHED FOR INSTALLATION OF NEW WALLS. NEW WALLS TO BE CONSTRUCTED AS TYPE SHOWN ON FLOOR PLAN SHEETS.
 - 6 REMOVE PLUMBING FIXTURES AND CAP BELOW SLAB.
 - 7 REPLACE EXISTING DOOR, FRAME TO REMAIN. REUSE EXISTING HARDWARE.
 - 8 REMOVE EXISTING LADDER AND INTERSTITIAL SPACE ACCESS DOOR.
 - 9 REMOVE EXISTING RAMP AND PREPARE SLAB FOR NEW FULL CORRIDOR WIDTH CONCRETE RAMP AND FINISH.

BUILDING IS FULLY SPRINKLERED

Revisions:	Date:		CONSULTANTS: 9201 West Broadway Brooklyn Park, MN 55445 Tel: 763.315.7600 Fax: 763.315.7920	 Smith Seckman Reid, Inc. 8055 E. Teller Ave. Suite 1100 Denver, CO 80231 (303) 778-1223 FAX: (303) 694-9144 www.ssr-inc.com	ARCHITECT/ENGINEERS: COX DESIGN ASSOCIATES ARCHITECTURE PLANNING INTERIORS Austin 5121 Bee Caves Road, Suite 203 Austin, Texas 78746 Chicago 345 N. Canal St. Suite 701 Chicago, IL 60605 T: 512-327-4149 F: 512-327-7679 T: 312-454-9434 F: 312-454-9439 coxdesign@austin.tx.com bcox@coxtd.com	Approved: Medical Center Director Approved: Associate Director Approved: Chief, Facility Mgmt	Approved: Safety Officer Approved: Chief, IT Approved: Service Chief	Approved: Chief, EMS Approved: Chief, Infection Control Approved: Chief, Police	Drawing Title 6TH FLOOR - DEMOLITION PLAN Location GRAND JUNCTION VAMC 2121 NORTH AVENUE GRAND JUNCTION, CO 81501	Project Name RENOVATE 6TH FLOOR Project Number 575-12-102 Date 12 APRIL 2013 Drawing Number 1-AS102 Building Number 1 Checked RHC Drawn CAW Dwg. of	Office of Construction and Facilities Management
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EXISTING WALLS TO REMAIN

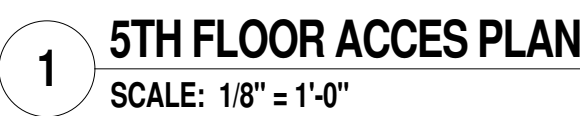A. HATCHED AREAS INDICATE LOCATIONS WHERE THE EXISTING CEILINGS ON THE 5TH FLOOR WILL REQUIRE TEMPORARY REMOVAL TO PROVIDE ACCESS FOR UNDERFLOOR WORK BEING PERFORMED FOR THE 6TH FLOOR ABOVE.

B. CONTRACTOR IS RESPONSIBLE FOR REMOVING CEILING FOR UNDERFLOOR CONSTRUCTION. REMOVED PORTION OF THE EXISTING CEILING MUST BE REPLACED AT THE END OF EACH WORKDAY OR THE IMMEDIATE AREA OF CONSTRUCTION MUST BE TREATED AS A CONSTRUCTION ZONE. COMPLETE WITH DUST-PROOF PARTITIONS AS SHOWN ON DETAIL 5/1-A18

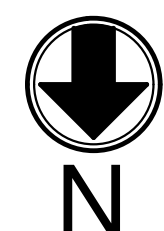
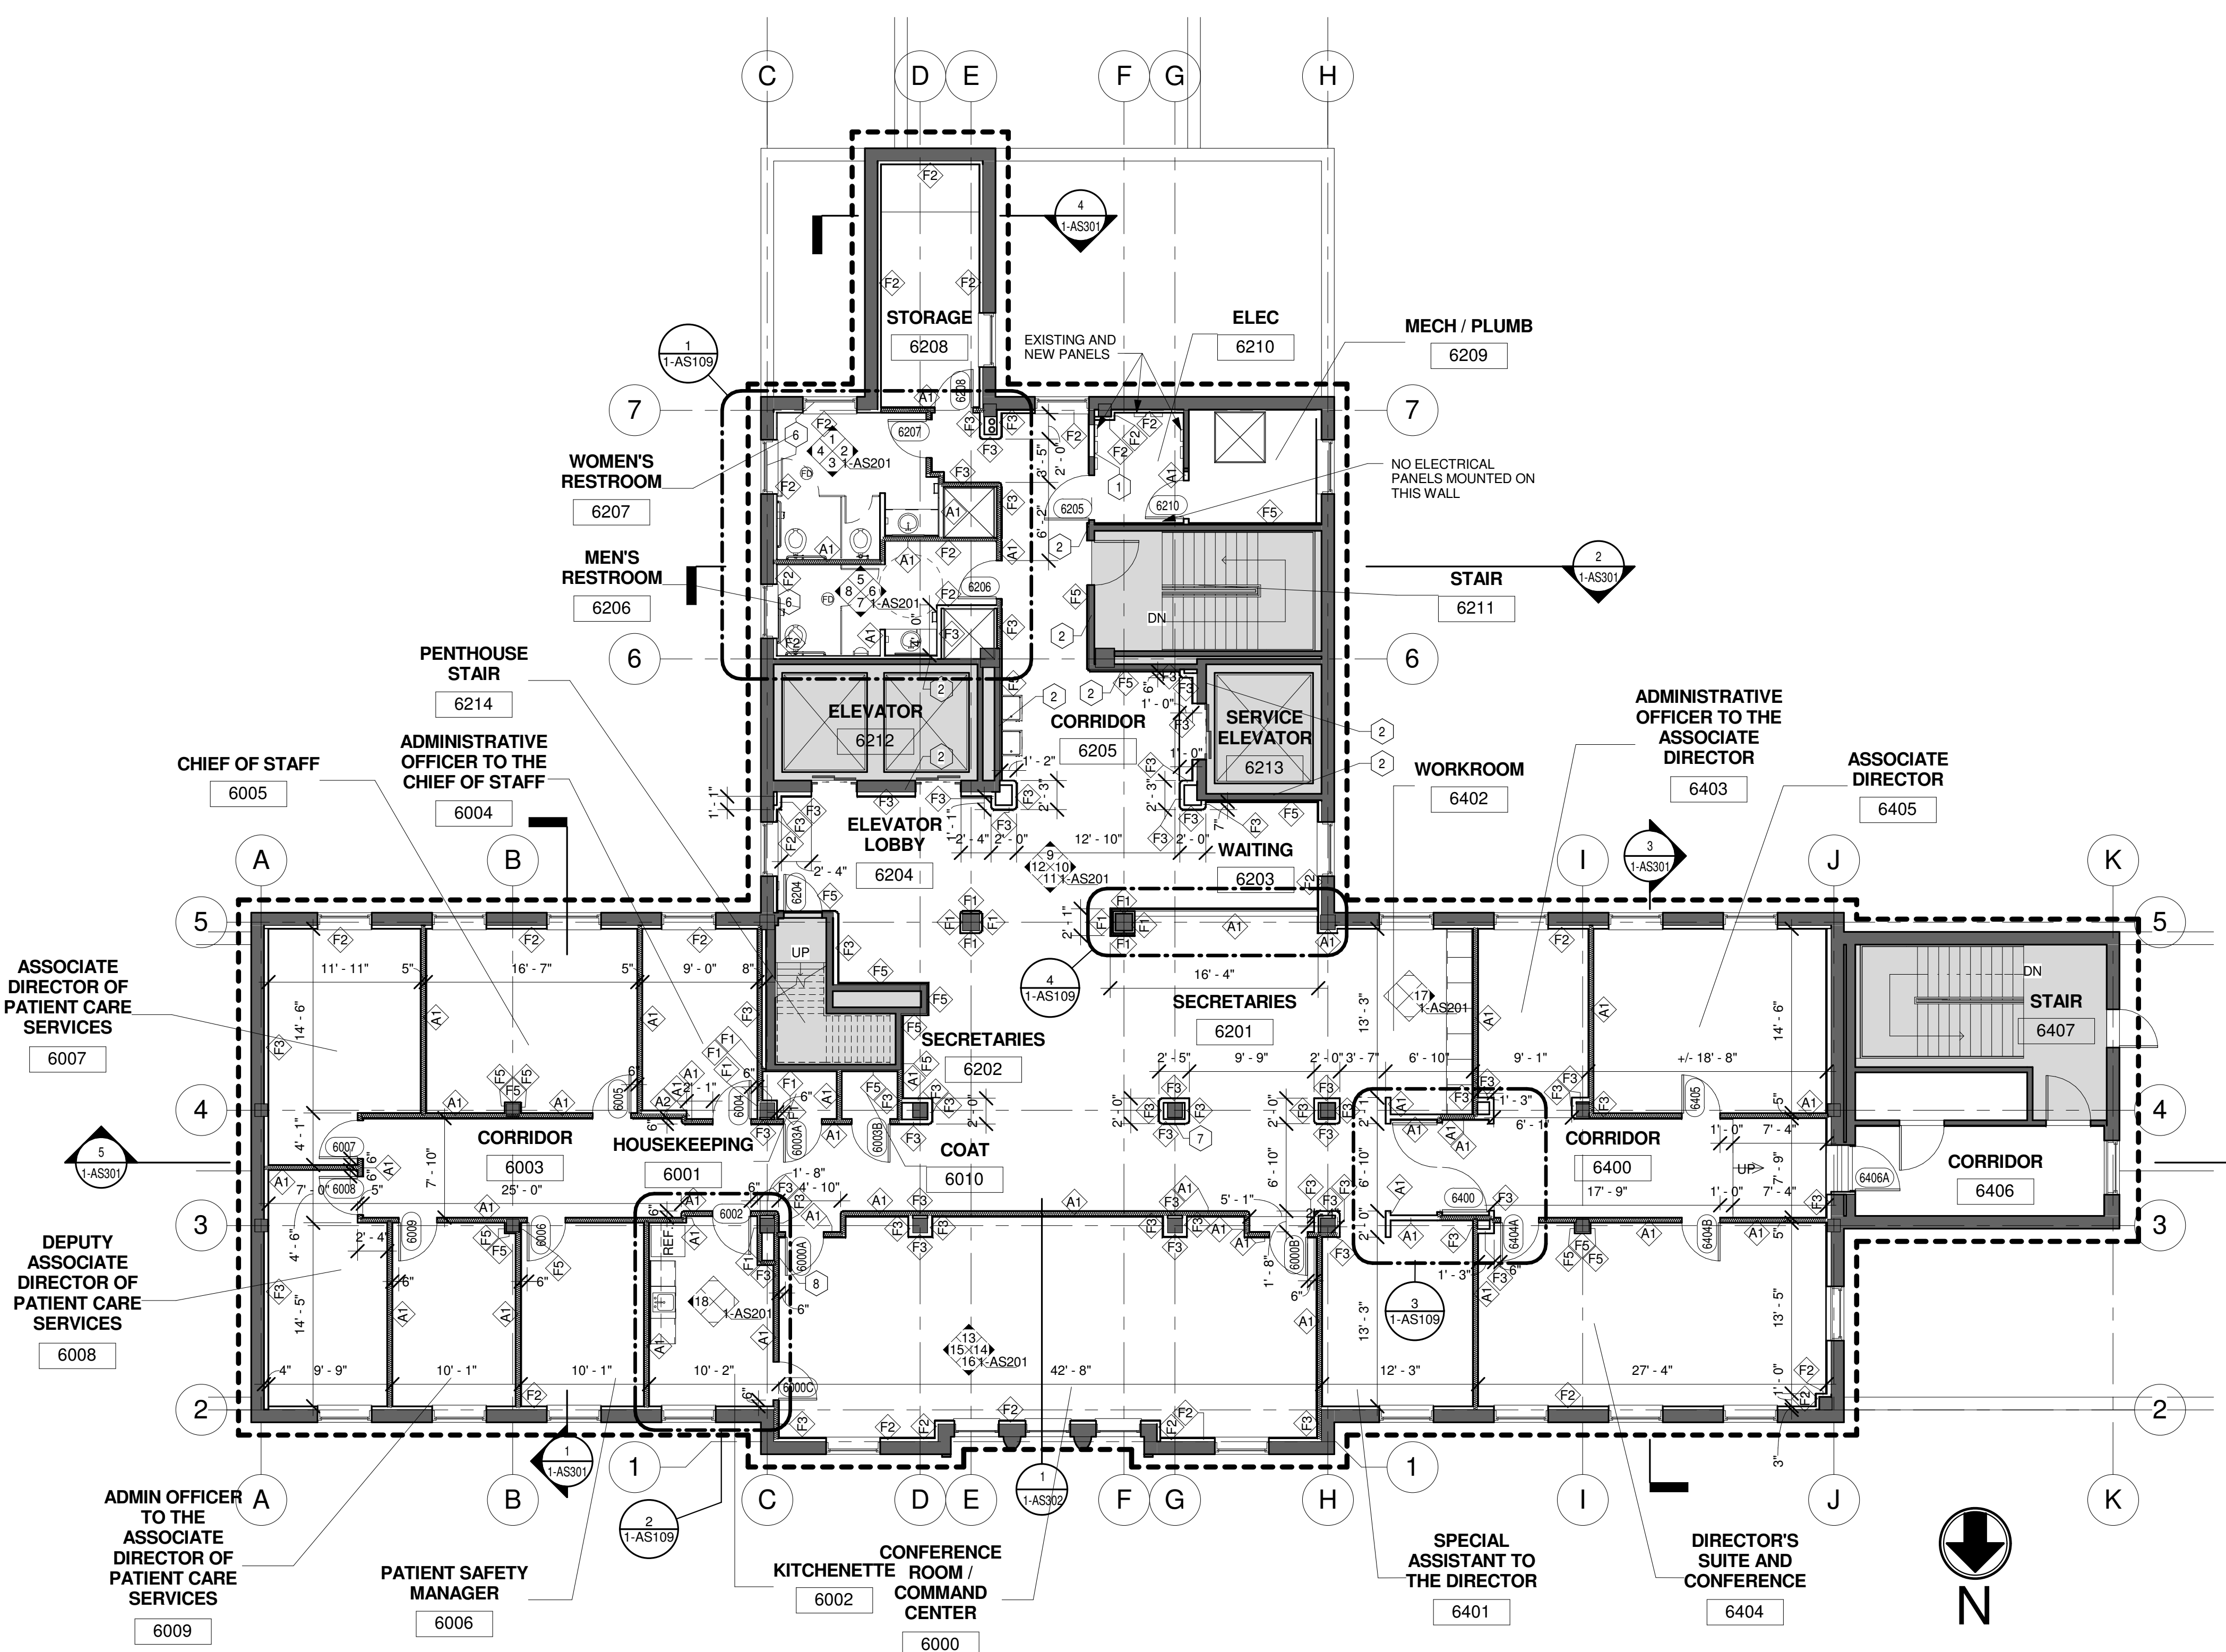
C. UPON COMPLETION OF CONSTRUCTION, CONTRACTOR IS RESPONSIBLE FOR RETURNING AND/OR REPAIRING ANY REMOVED PORTION OF CEILING TO A CONDITION EQUAL TO OR BETTER THAN THAT OF THE ADJACENT EXISTING CEILING CONDITIONS.

D. IN AREAS WHERE PLASTER TYPE CEILINGS ARE REMOVED, REPLACE WITH ACoustIC CEILING TILE. ACOUSTIC CEILING TILE IS TO MATCH ADJACENT TYPE AND MODEL.

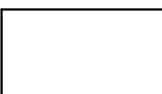
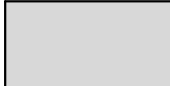




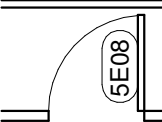


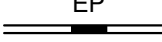

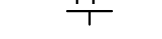
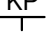
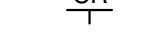

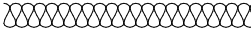
**BUILDING IS
FULLY
SPRINKLERED**

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A
three inches = one foot
B
one and one half inches = one foot
C
one inch = one foot
D
three quarters inch = one foot
E
one half inch = one foot
F
one quarter inch = one foot
G
one eighth inch = one foot
H
one quarter inch = one foot
I
one eighth inch = one foot
J
one quarter inch = one foot
K
one eighth inch = one foot



1 6TH FLOOR PLAN
SCALE: 1/8" = 1'-0"

GRAPHIC LEGEND			
FLOOR PLAN - SYMBOLS LEGEND			
	AREA IN CONTRACT		AREA NOT IN CONTRACT
	CONSTRUCTION LIMITS		MODULAR CASEWORK, SEE SHEET 1-CW1 & 1-CW2 FOR MODULAR CASEWORK, PROVIDED AND INSTALLED BY CONTRACTOR
	EXISTING WALL TO REMAIN		MILLWORK PROVIDED AND INSTALLED BY CONTRACTOR
	NEW WALL / PARTITION		
	NEW DOOR		PARTITION TYPE
	RECESSED FIRE EXTINGUISHER CABINET		FLOOR DRAIN
	ELECTRICAL PANEL		ELECTRONIC KEY PAD LOCK
	AUTOMATIC DOOR OPERATOR		CONSTRUCTION LIMITS
	CARD READER		IN-WALL SOUND ATTENUATION INSULATION

SHEET NOTES	
A. DIMENSIONS ON FLOOR PLAN ARE BASED ON FACE OF FINISHED WALL TO FACE OF FINISHED WALL (NOMINAL)	
B. VERIFY ALL DIMENSIONS AND CONDITIONS AT JOB SITE.	
C. MAINTAIN CONTINUOUS UTILITY SERVICE TO ALL SPACES IN THE BUILDING NOT AFFECTED BY THIS WORK. COORDINATE WITH OWNER AND DISRUPTION IN SERVICES REQUIRED TO PERFORM WORK OR TO MODIFY EXISTING PIPING, DUCTWORK, OR ANY ASSOCIATED EQUIPMENT.	
D. REFER TO SHEET 1-AS601 FOR ROOM FINISH SCHEDULE AND NOTES. REFER TO SHEET 1-AS602 FOR DOOR SCHEDULES, DOOR TYPES, AND NOTES.	
F. IN-WALL SUPPORT BLOCKING TO BE PROVIDED AT ALL DOOR WALL STOP LOCATIONS PER DETAIL S/1-A17.	
G. HILTI SPEED SLEEVE OR APPROVAL EQUAL REQUIRED FOR CONDUIT AND PIPING PENETRATIONS THROUGH FIRE RATED WALLS.	
H. ALL WET AREAS TO RECEIVE NEW TILE FLOORING AS INDICATED ON THE ROOM FINISH SCHEDULE AND ARE TO RECEIVE A WATERPROOFING MEMBRANE	
I. DEMOLITION AS REQUIRED FOR ABATEMENT IS TO BE RECONSTRUCTED BY CONTRACTOR AS REQUIRED TO MATCH ADJACENT CONDITIONS	
KEY NOTES	

GYPSUM BOARD PARTITION SCHEDULE	
SOUND PARTITION	
A1	3 5/8" STEEL STUDS @ 16" O.C. W/ 3" SOUND ATTENUATION INSULATION & 5/8" GYP BD @ EACH FACE. PROVIDE 1HR RATED UL # U465 DESIGN WHERE 1HR CONSTRUCTION IS INDICATED ON PLANS - SEE LIFE SAFETY PLANS
A2	6" STEEL STUDS @ 16" O.C. W/ 6" SOUND ATTENUATION INSULATION & 5/8" GYP BD @ EACH FACE. PROVIDE 1HR RATED UL # U465 DESIGN WHERE 1HR CONSTRUCTION IS INDICATED ON PLANS - SEE LIFE SAFETY PLANS


FURRING	
F	DIRECT BONDED 5/8" GYP BD
F3	3 5/8" STEEL STUDS @ 16" OC W/ 5/8" GYP BD
F1	1 5/8" STEEL STUDS @ 16" OC W/ 5/8" GYP BD
F4	3 5/8" STEEL STUDS @ 16" OC W/ 3" SOUND ATTENUATION INSULATION & 5/8" GYP BD
F2	2 1/2" STEEL STUDS @ 16" OC W/ 5/8" GYP BD
F5	7/8" STEEL HAT CHANNEL @ 16" OC W/ 5/8" GYP BD








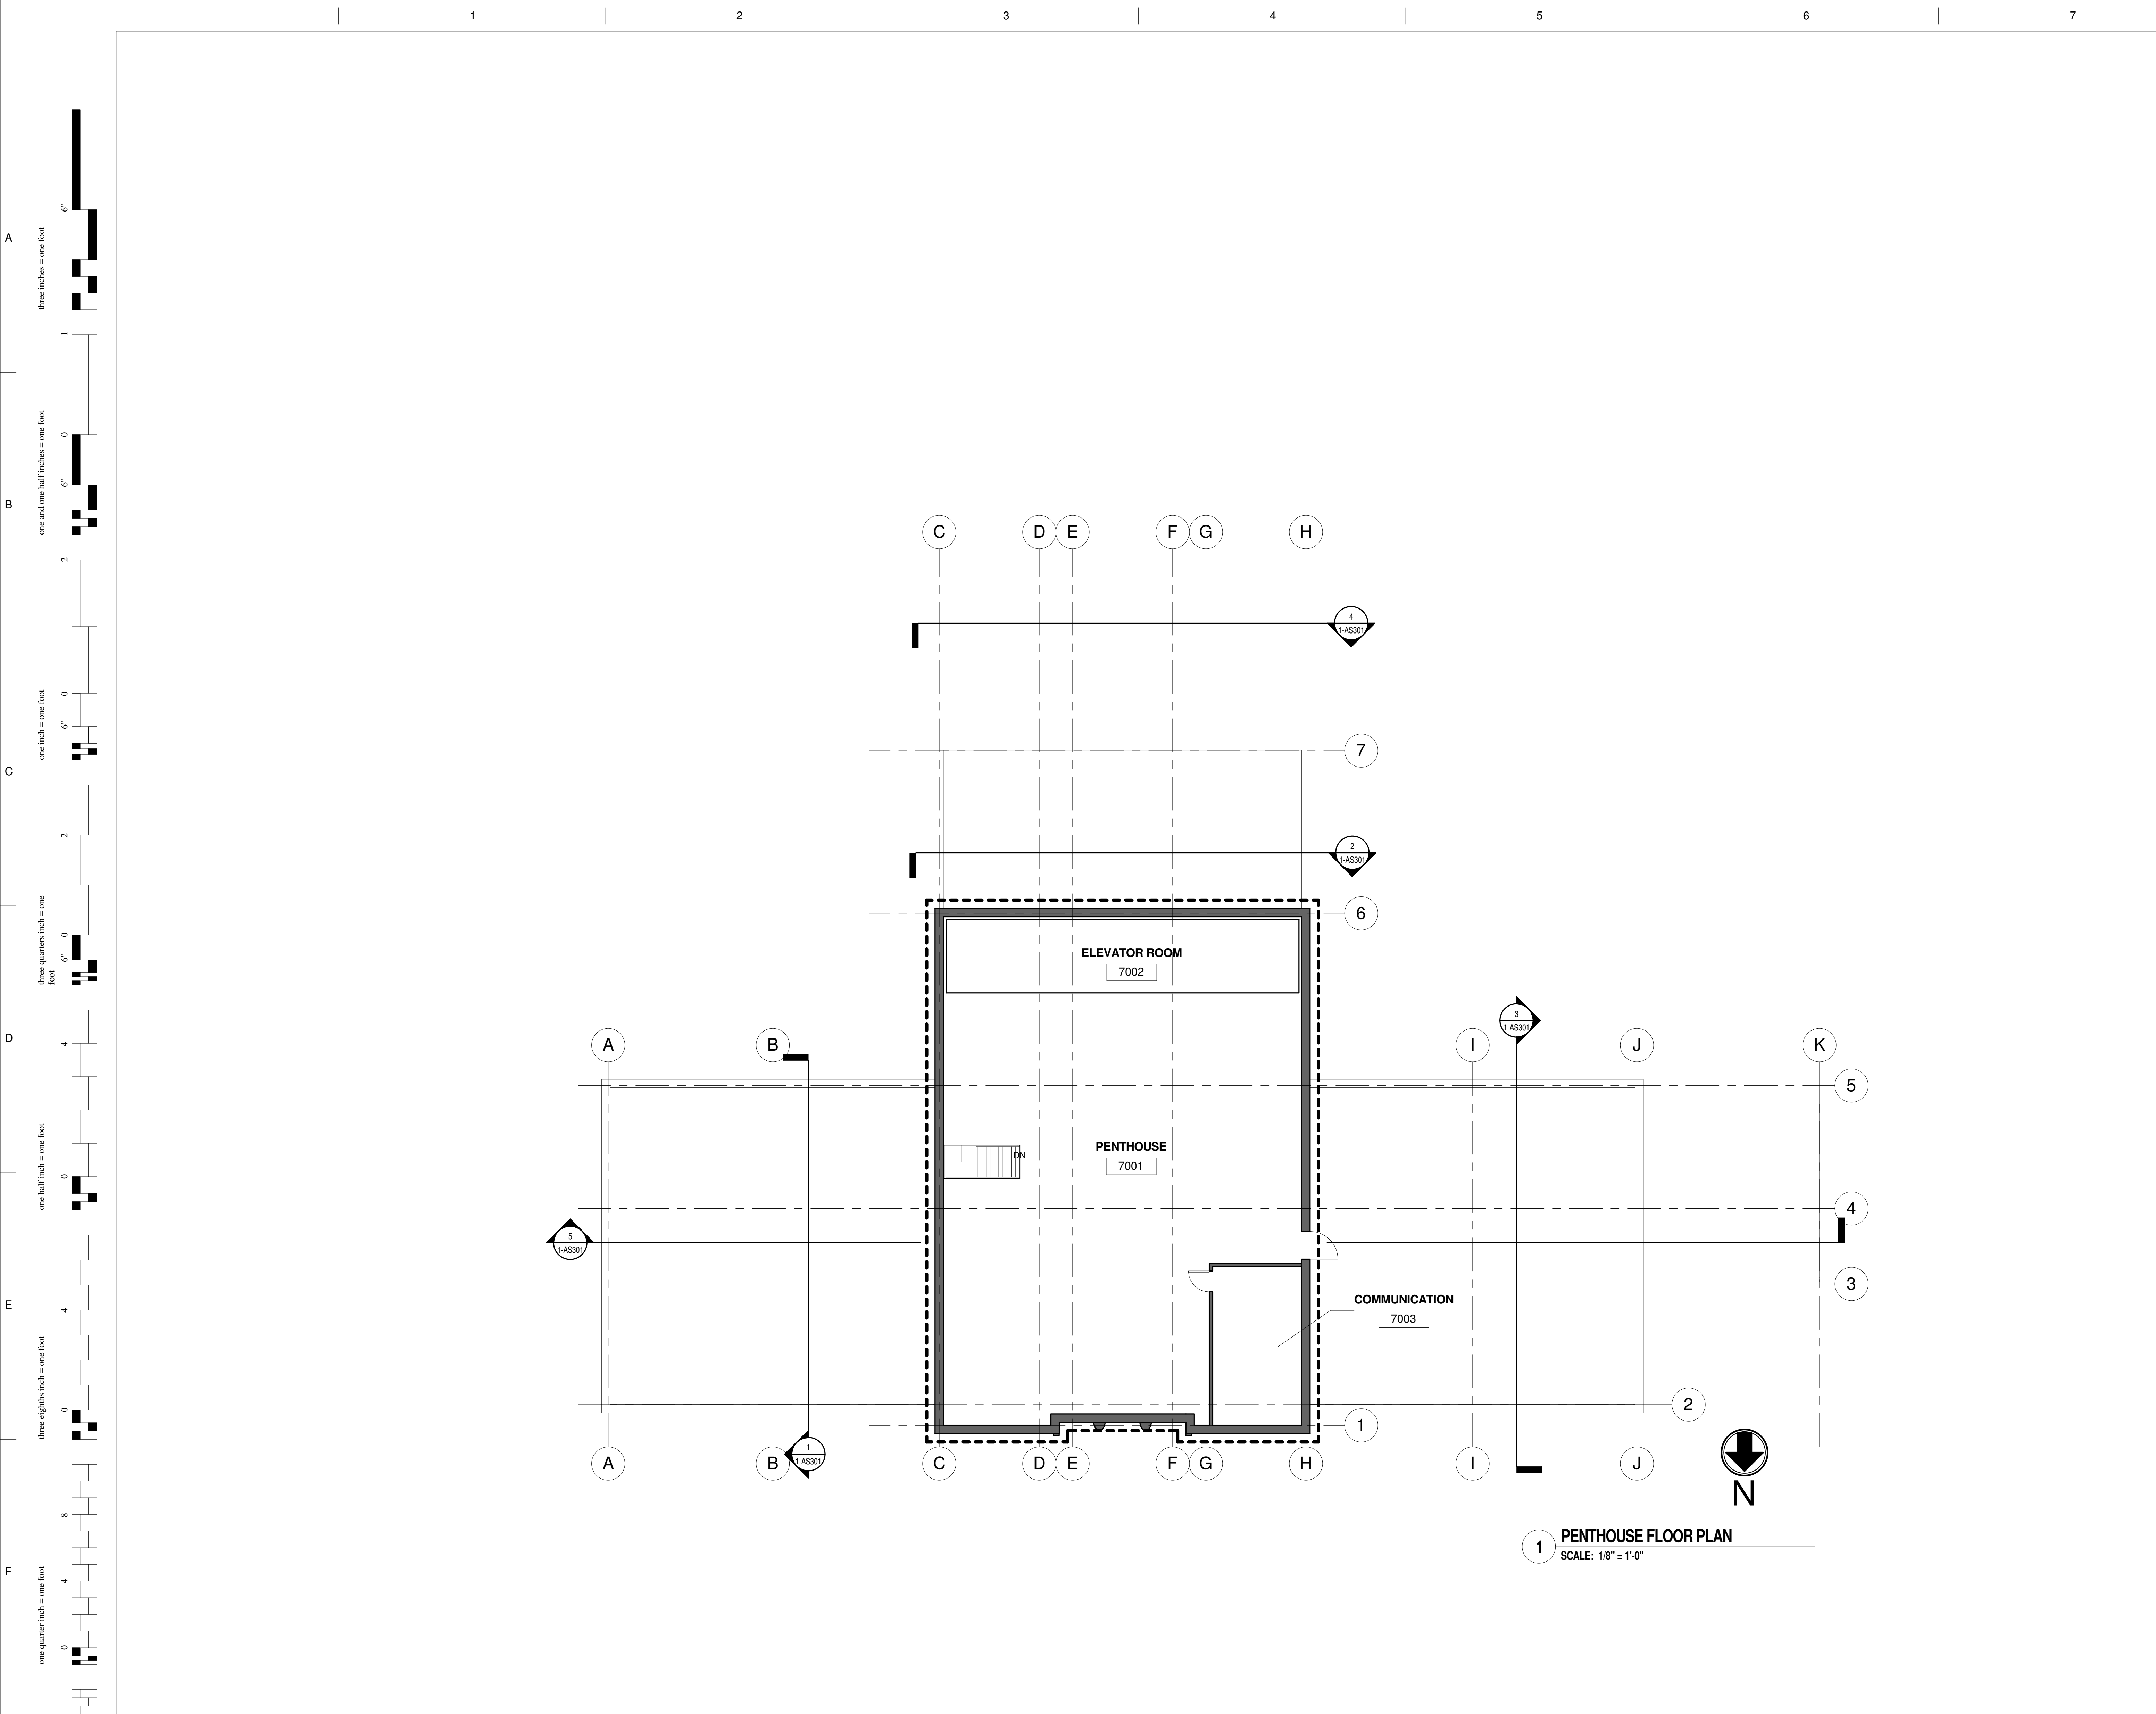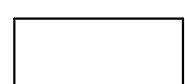
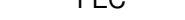







GYPSUM BOARD PARTITION GENERAL NOTES	
1. ALL GYP BD PARTITIONS SHALL BE A1 UNLESS OTHERWISE NOTED ON FLOOR PLANS	
2. GYP BD PARTITION DIMENSIONS ON FLOOR PLAN ARE BASED ON FACE OF FINISHED PARTITION TO FACE OF FINISHED PARTITION (NOMINAL).	
3. REFER TO GYP BD SPECIFICATION FOR LOCATIONS & TYPE(S) OF GYPSUM BOARD MATERIAL REQUIRED.	
4. PROVIDE TYPE "X" FIRE RATED GYPSUM BOARD AT ALL FIRE RATED PARTITIONS. SEAL ALL WALL PENETRATIONS AT PERIMETER AND FIRESTOP ALL FIRE RATED PARTITIONS. REFERENCE "LIFE SAFETY PLANS" FOR WALL RATINGS	
5. NOISE TRANSMISSION CONTROL PROVIDED IN ALL OFFICES	

FLOOR PLAN KEYED NOTES	
1	INFILL PREVIOUS DOOR LOCATION WITH WALL TYPE THAT MATCHES ADJACENT FIRE RATING AND FINISH.
2	PATCH EXISTING WALL AS REQUIRED TO MATCH EXISTING ADJACENT WALL CONSTRUCTION. MAINTAIN EXISTING WALL RATING
3	EXISTING WINDOW SILL TO BE REFINISHED WITH NEW SOLID SURFACE VENEER. SEE 1/1-AS104 FOR LOCATIONS WHERE FAN COIL UNIT AND ENCLOSURE IS SHOWN. SEE DETAIL 2 AND 3 ON SHEET 1-AS503 FOR LOCATIONS WHERE NO FAN COIL UNIT IS PRESENT. FIELD VERIFY ALL DIMENSIONS. PROVIDE WALL TYPE F5 UP TO THE BOTTOM OF THE WINDOW SILL.
4	WALL MOUNTED STORAGE BIN SYSTEM PROVIDED BY OWNER AND INSTALLED BY CONTRACTOR. CONFIRM EXACT LOCATION AND CONFIGURATION WITH OWNER PRIOR TO INSULATION.
5	PROVIDE NEW WINDOW SILL VENEER AND WALL FURRING TYP F2 TO ALLOW FOR GRAB BAR BLOCKING. SEE DETAIL 3/1-AS503 PROVIDE F4 FURRING AT LOCATIONS SHOWN WITH A DEEPER WINDOW SILL.
6	REPLACE EXISTING CLEAR GLAZING WITH TRANSLUCENT PRIVACY GLAZING.
7	"CODE BLUE" CALL BUTTON
8	IN-WALL COMMUNICATION SYSTEM STATION

BUILDING IS FULLY SPRINKLERED

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GRAPHIC LEGEND			
FLOOR PLAN - SYMBOLS LEGEND			
	AREA IN CONTRACT		AREA NOT IN CONTRACT
	CONSTRUCTION LIMITS		MODULAR CASEWORK, SEE SHEET 1-CW1 & 1-CW2 FOR MODULAR CASEWORK, PROVIDED AND INSTALLED BY CONTRACTOR
	EXISTING WALL TO REMAIN		MILLWORK PROVIDED AND INSTALLED BY CONTRACTOR
	NEW WALL / PARTITION		PARTITION TYPE
	NEW DOOR		FLOOR DRAIN
	RECESSED FIRE EXTINGUISHER CABINET		CONSTRUCTION LIMITS
	ELECTRICAL PANEL		IN-WALL SOUND ATTENUATION INSULATION
	AUTOMATIC DOOR OPERATOR		
	CARD READER		

SHEET NOTES

- A. DIMENSIONS ON FLOOR PLAN ARE BASED ON FACE OF FINISHED WALL TO FACE OF FINISHED WALL (NOMINAL)
- B. VERIFY ALL DIMENSIONS AND CONDITIONS AT JOB SITE.
- C. MAINTAIN CONTINUOUS UTILITY SERVICE TO ALL SPACES IN THE BUILDING NOT AFFECTED BY THIS WORK. COORDINATE WITH OWNER AND DISRUPTION IN SERVICES REQUIRED TO PERFORM WORK OR TO MODIFY EXISTING PIPING, DUCTWORK, OR ANY ASSOCIATED EQUIPMENT.
- D. REFER TO SHEET 1-AS601 FOR ROOM FINISH SCHEDULE AND NOTES. REFER TO SHEET 1-AS602 FOR DOOR SCHEDULES, DOOR TYPES, AND NOTES.
- F. IN-WALL SUPPORT BLOCKING TO BE PROVIDED AT ALL DOOR WALL STOP LOCATIONS PER DETAIL 5/1-A17.
- G. HILTI SPEED SLEEVE OR APPROVAL EQUAL REQUIRED FOR CONDUIT AND PIPING PENETRATIONS THROUGH FIRE RATED WALLS.
- H. ALL WET AREAS TO RECEIVE NEW TILE FLOORING AS INDICATED ON THE ROOM FINISH SCHEDULE AND ARE TO RECEIVE A WATERPROOFING MEMBRANE
- I. DEMOLITION AS REQUIRED FOR ABATEMENT IS TO BE RECONSTRUCTED BY CONTRACTOR AS REQUIRED TO MATCH ADJACENT CONDITIONS

KEY NOTES

GYPSUM BOARD PARTITION SCHEDULE

- A1** 3"X8" STEEL STUDS @ 16" O.C. W/ 3" SOUND ATTENUATION INSULATION & 5/8" GYP BD @ EACH FACE. PROVIDE 1HR RATED UL # U465 DESIGN WHERE 1HR CONSTRUCTION IS INDICATED ON PLANS - SEE LIFE SAFETY PLANS
- A2** 6" STEEL STUDS @ 16" O.C. W/ 6" SOUND ATTENUATION INSULATION & 5/8" GYP BD @ EACH FACE. PROVIDE 1HR RATED UL # U465 DESIGN WHERE 1HR CONSTRUCTION IS INDICATED ON PLANS - SEE LIFE SAFETY PLANS

- | FURRING | |
|---|---|
| F DIRECT BONDED 5/8" GYP BD | F3 3 5/8" STEEL STUDS @ 16" OC W/ 5/8" GYP BD |
| F1 1 5/8" STEEL STUDS @ 16" OC W/ 5/8" GYP BD | F4 3 5/8" STEEL STUDS @ 16" OC W/ 3" SOUND ATTENUATION INSULATION & 5/8" GYP BD |
| F2 2 1/2" STEEL STUDS @ 16" OC W/ 5/8" GYP BD | F5 7/8" STEEL HAT CHANNEL @ 16" OC W/ 5/8" GYP BD |

GYP SUM BOARD PARTITION GENERAL NOTES


1. ALL GYP BD PARTITIONS SHALL BE A1 UNLESS OTHERWISE NOTED ON FLOOR PLANS
2. GYP BD PARTITION DIMENSIONS ON FLOOR PLAN ARE BASED ON FACE OF FINISHED PARTITION TO FACE OF FINISHED PARTITION (NOMINAL).
3. REFER TO GYP BD SPECIFICATION FOR LOCATIONS & TYPE(S) OF GYPSUM BOARD MATERIAL REQUIRED.
4. PROVIDE TYPE "X" FIRE RATED GYPSUM BOARD AT ALL FIRE RATED PARTITIONS. SEAL ALL WALL PENETRATIONS AT PERIMETER AND FIRESTOP ALL FIRE RATED PARTITIONS.
5. REFERENCE "LIFE SAFETY PLANS" FOR WALL RATINGS
6. NOISE TRANSMISSION CONTROL PROVIDED IN ALL OFFICES

FLOOR PLAN KEYED NOTES

- ① INFILL PREVIOUS DOOR LOCATION WITH WALL TYPE THAT MATCHES ADJACENT FIRE RATING AND FINISH.
- ② PATCH EXISTING WALL AS REQUIRED TO MATCH EXISTING ADJACENT WALL CONSTRUCTION. MAINTAIN EXISTING WALL RATING
- ③ EXISTING WINDOW SILL TO BE REFINISHED WITH NEW SOLID SURFACE VENEER. SEE 1/1-AS104 FOR LOCATIONS WHERE FAN COIL UNIT AND ENCLOSURE IS SHOWN. SEE DETAIL 2 AND 3 ON SHEET 1-AS503 FOR LOCATIONS WHERE NO FAN COIL UNIT IS PRESENT. FIELD VERIFY ALL DIMENSIONS. PROVIDE WALL TYPE F5 UP TO THE BOTTOM OF THE WINDOW SILL.
- ④ WALL MOUNTED STORAGE BIN SYSTEM PROVIDED BY OWNER AND INSTALLED BY CONTRACTOR. CONFIRM EXACT LOCATION AND CONFIGURATION WITH OWNER PRIOR TO INSULATION.
- ⑤ PROVIDE NEW WINDOW SILL VENEER AND WALL FURRING TYP F2 TO ALLOW FOR GRAB BAR BLOCKING. SEE DETAIL 3/1-AS503 PROVIDE F4 FURRING AT LOCATIONS SHOWN WITH A DEEPER WINDOW SILL.
- ⑥ REPLACE EXISTING CLEAR GLAZING WITH TRANSLUCENT PRIVACY GLAZING.
- ⑦ "CODE BLUE" CALL BUTTON
- ⑧ IN-WALL COMMUNICATION SYSTEM STATION

**BUILDING IS
FULLY
SPRINKLERED**

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**BUILDING IS
FULLY
SPRINKLERED**



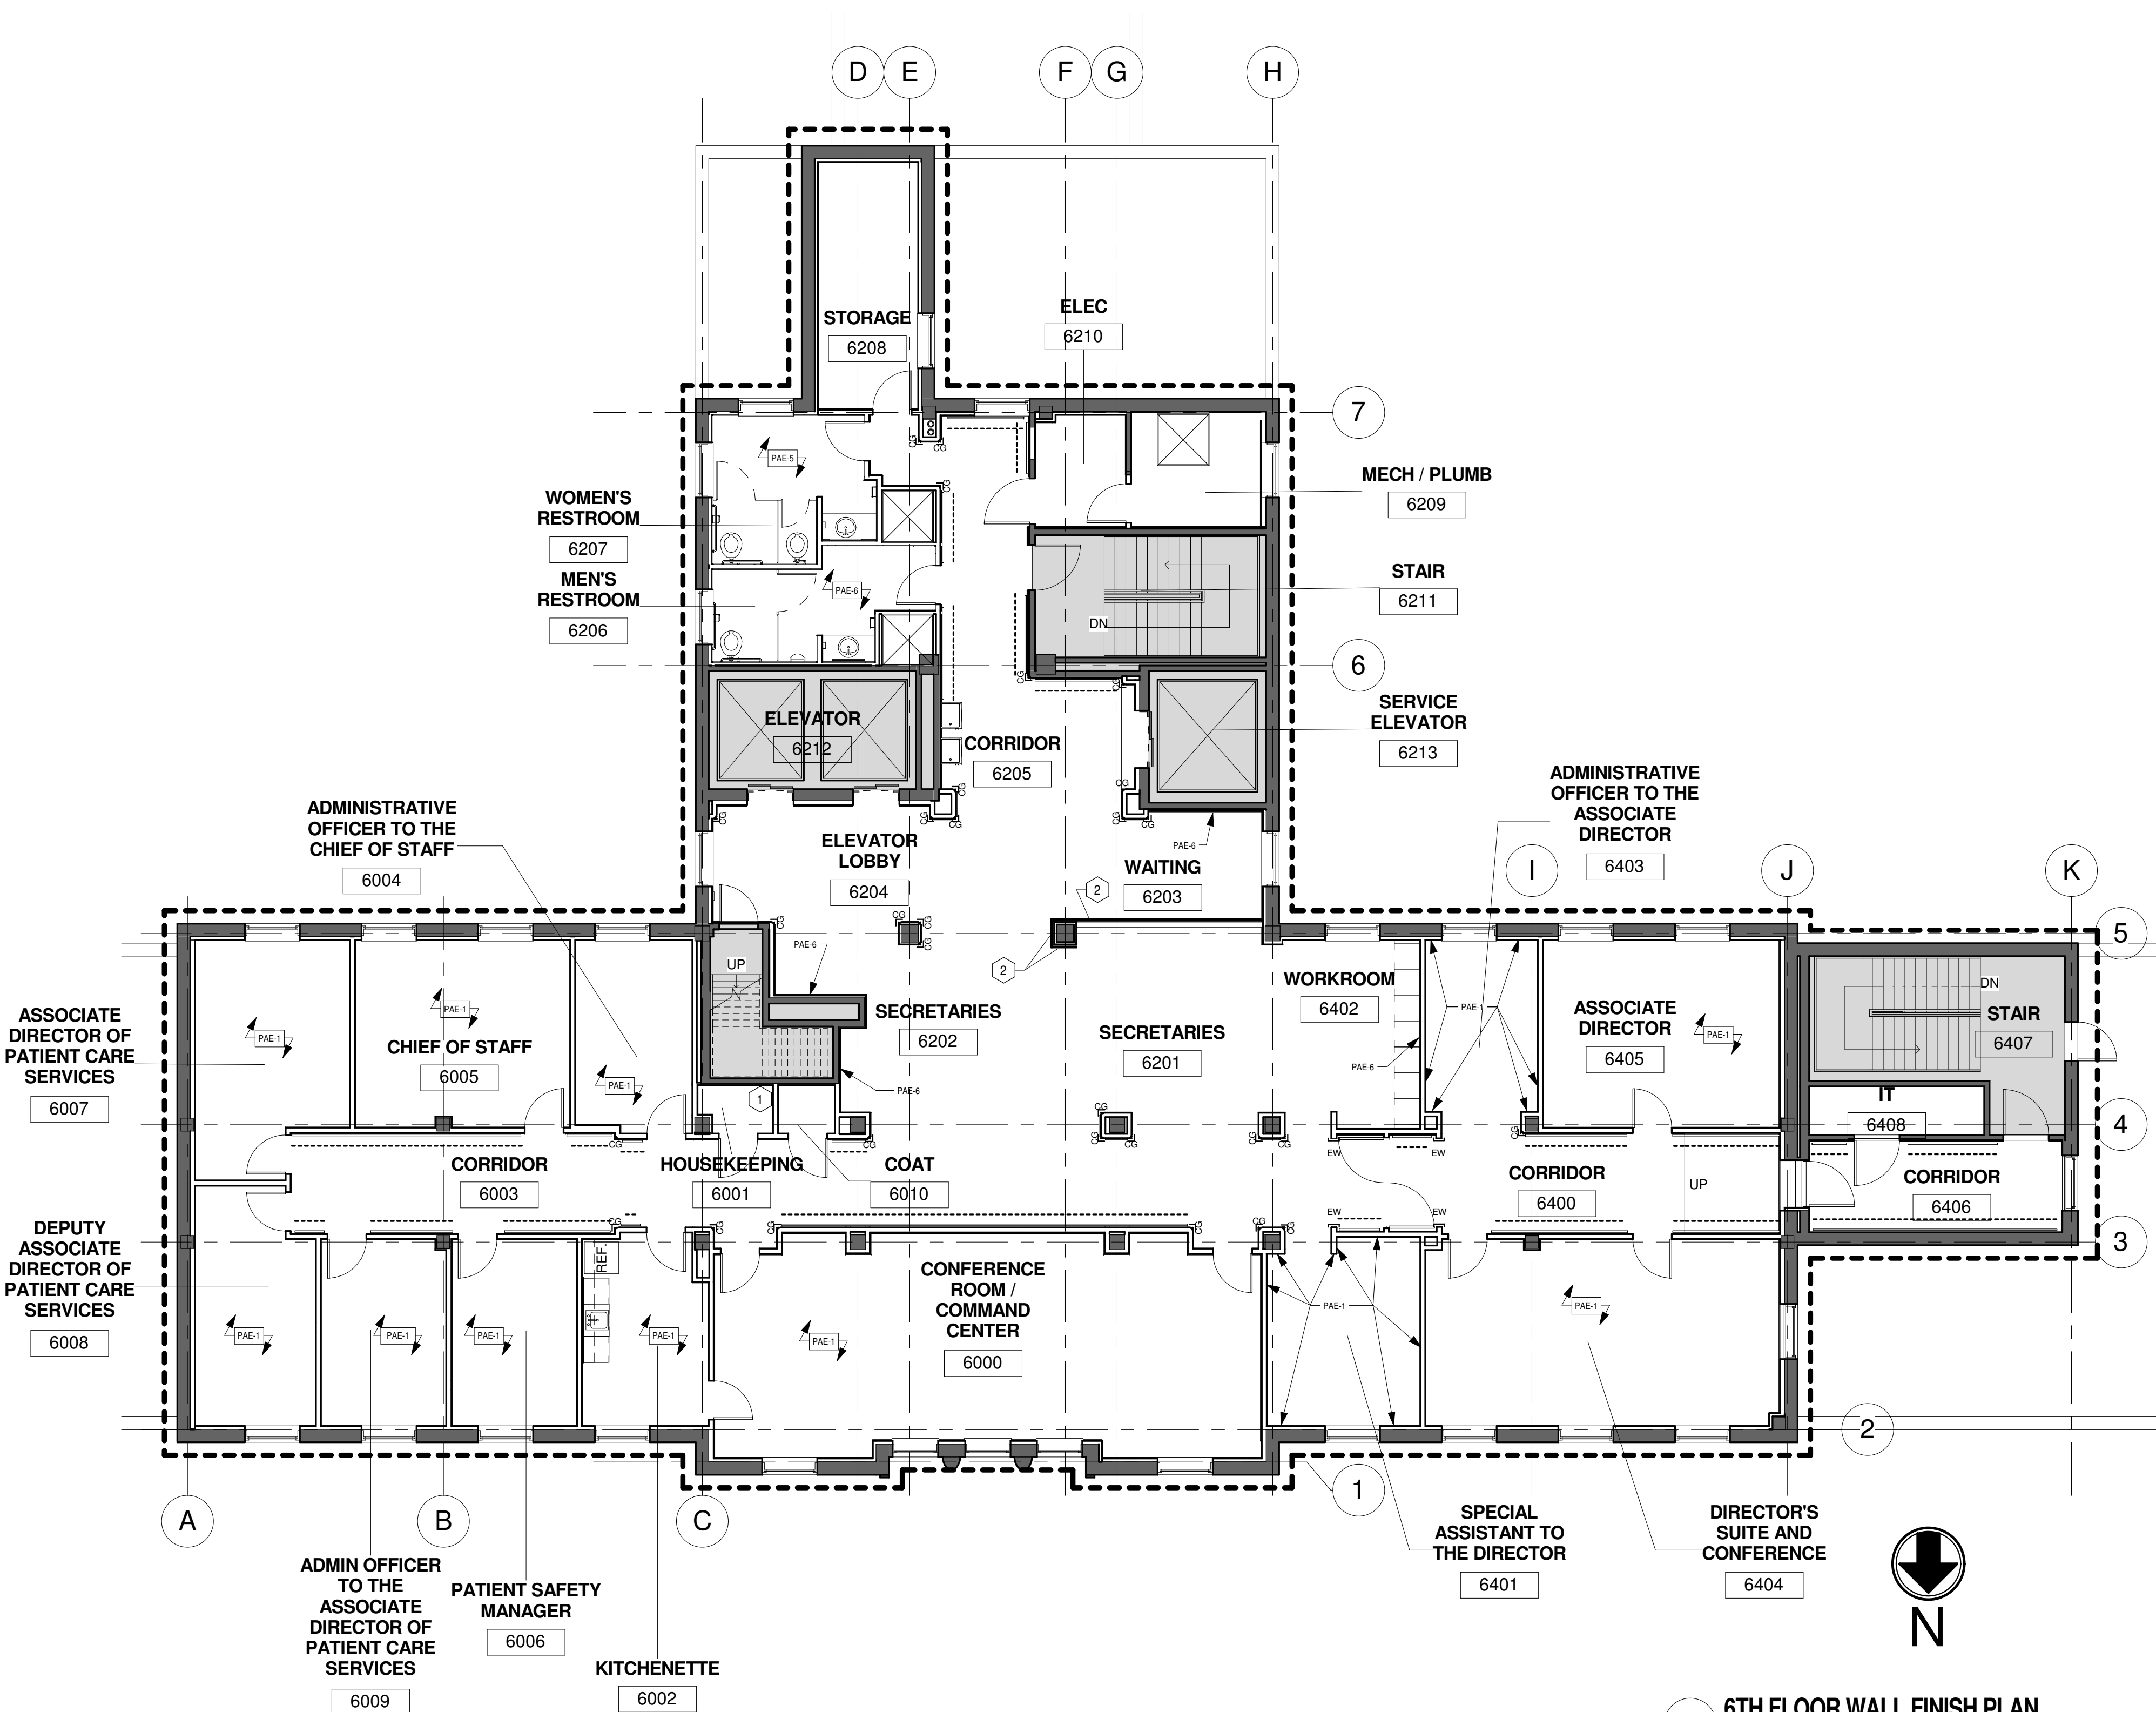
Office of
Construction
and Facilities
Management

 Department of
Veterans Affairs

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three inches = one foot
one and one half inches = one foot
one inch = one foot
three quarters inch = one foot
one half inch = one foot
three eighths inch = one foot
one quarter inch = one foot
one eighth inch = one foot

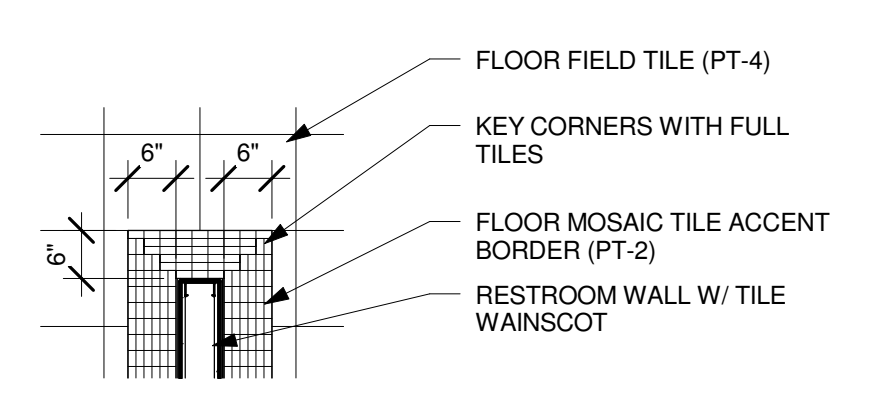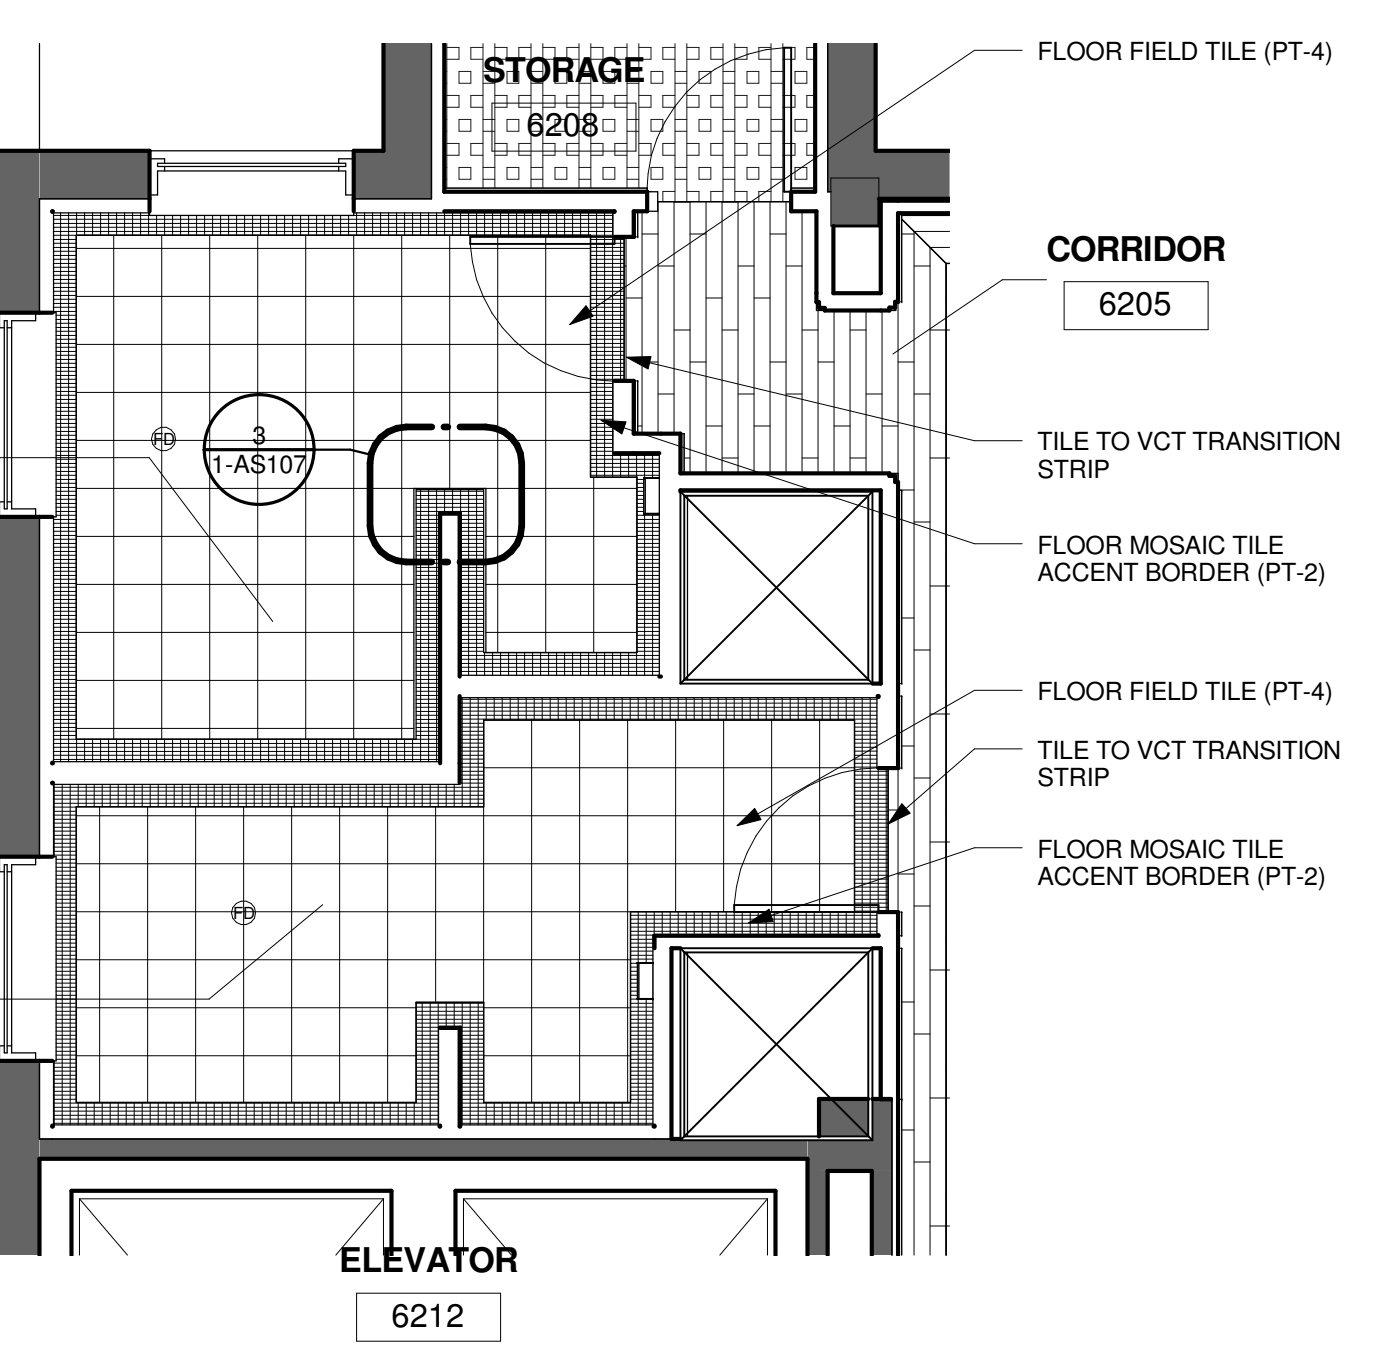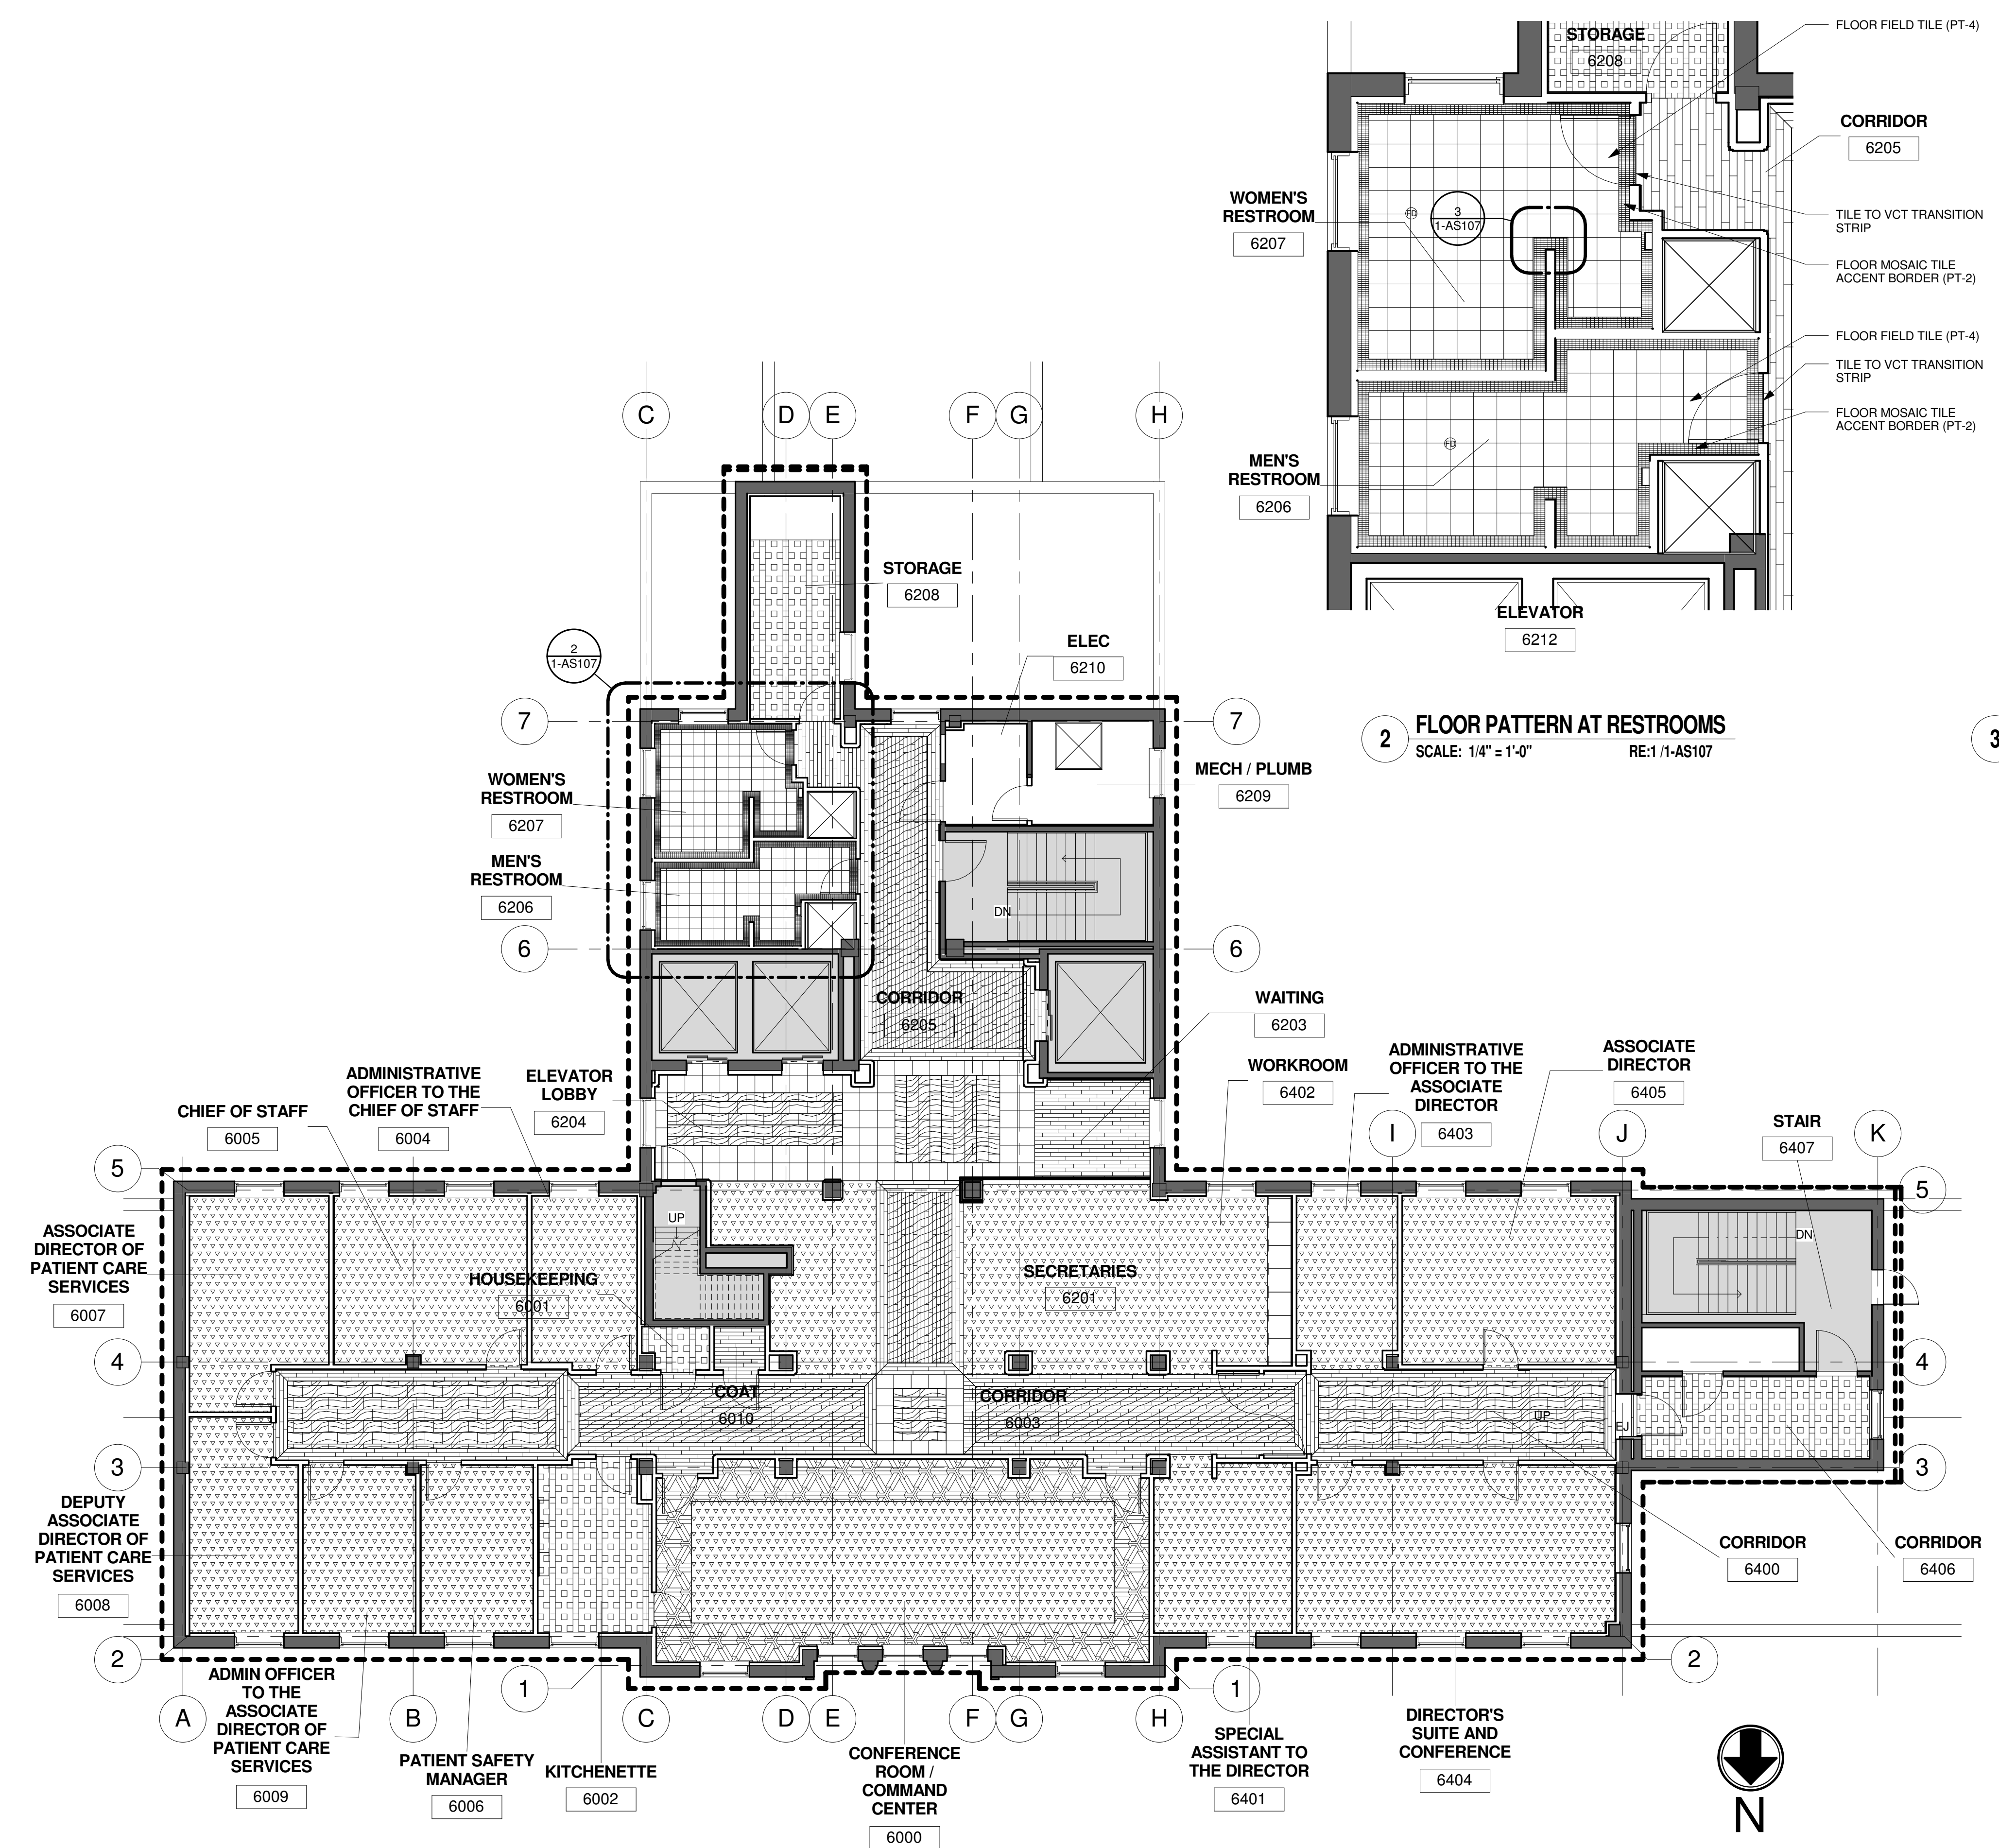A
B
C
D
E
F



GRAPHIC LEGEND			
	AREA IN CONTRACT		AREA NOT IN CONTRACT
NF	NO FINISH		
-----	CONSTRUCTION LIMITS		
FLOOR TILE			
	HP -1		HP -2
	HP-3		HP-4 (ALTERNATE GRAIN DIRECTION)
	VCT -1 (ALTERNATE GRAIN DIRECTION)		
RESTROOM FLOOR TILE			
	PT-2		PT-4 (ALTERNATE GRAIN DIRECTION)
CARPET			
	CPT -1		CPT-2





SHEET NOTES	
A	CONTRACTOR SHALL REMOVE EXISTING FLOORING MATERIALS ENTIRELY AND PREPARE CONCRETE FLOORS AS SPECIFIED FOR INSTALLATION OF NEW FLOORING MATERIALS AS SCHEDULED.
B	CONTRACTOR SHALL INSTALL NEW FLOORING IN PATTERNS INDICATED TO THE GREATEST EXTENT POSSIBLE. PATTERN DEVIATIONS SHALL BE APPROVED BY THE C.O.R. PRIOR TO INSTALLATION.
C	TERMINATE OR TRANSITION DISSIMILAR FLOORING MATERIALS AT THE CENTERLINE OF DOORS.
D	PROVIDE A FLUSH TRANSITION BETWEEN FLOORING MATERIALS OF VARYING HEIGHTS. PROVIDE TRANSITION STRIPS AS INDICATED ON MATERIAL SCHEDULE.
E	INSTALL NEW DOOR STOPS
F	FLOORING TO RUN CONTINUOUSLY BENEATH ALL CASEWORK.
G	DIFFERENT FLOOR MATERIALS ADJACENT TO EACH OTHER ARE TO BE FLUSH. FEATHER AND ALIGN AS REQUIRED.
H	PROVIDE SLOPE TO FLOOR DRAINS, TYPICAL AT ALL TOILET ROOMS.
I	TRANSITION STRIPS TO BE PROVIDED AT JOINT OF DIFFERING MATERIALS
J	LOCATE ALL FLOORING TRANSITIONS UNDER DOORS

BUILDING IS FULLY SPRINKLERED

Revisions: Date:				CONSULTANTS: 9201 West Broadway Brooklyn Park, MN 55445 Tel: 763.315.7600 Fax: 763.315.7920		 Smith Seckman Reid, Inc. 3055 E. Taffs Ave. Suite 1100 Denver, CO 80237 (303) 778-1223 FAX: (303) 694-9144 www.ssr-inc.com		ARCHITECT/ENGINEERS: COX DESIGN ASSOCIATES ARCHITECTURE PLANNING INTERIORS Austin 5121 Bee Caves Road, Suite 203 Austin, Texas 78746 Chicago 345 N. Canal St. Suite 701 Chicago, IL 60605 T: 512 - 327 - 4149 T: 312 - 454 - 9434 F: 512 - 327 - 7679 F: 312 - 454 - 9439 coxdesign@austin.rr.com bcoc@coxtd.com		Approved: Medical Center Director Approved: Associate Director Approved: Chief, Facility Mgmt		Approved: Safety Officer Approved: Chief, IT Approved: Service Chief		Approved: Chief, EMS Approved: Chief, Infection Control Approved: Chief, Police		Drawing Title 6TH FLOOR - FLOOR FINISH PLAN Location GRAND JUNCTION VAMC 2121 NORTH AVENUE GRAND JUNCTION, CO 81501		Project Name RENOVATE 6TH FLOOR		Project Number 575-12-102 Date 12 APRIL 2013		Drawing Number 1-AS107 Dwg. of		Office of Construction and Facilities Management Department of Veterans Affairs	
Building Number 1		Checked RHC		Drawn PJ																					



----- CONSTRUCTION LIMITS


-  DOUBLE SIDED EXIT SIGNAGE CEILING MOUNTED
-  DOUBLE SIDED EXIT SIGNAGE CEILING MOUNTED WITH DIRECTIONAL ARROWS
-  SINGLE SIDED EXIT SIGNAGE CEILING MOUNTED
-  SINGLE SIDED EXIT SIGNAGE CEILING MOUNTED WITH DIRECTIONAL ARROWS

- | KEY NOTES | |
|-----------|---|
| 1 | CEILING MOUNTED FIRE RATED SCREEN, SEE DETAIL 2 / 1-AS108 |

Office of
Construction
and Facilities
Management

Department of
Veterans Affairs

12 APRIL 2013

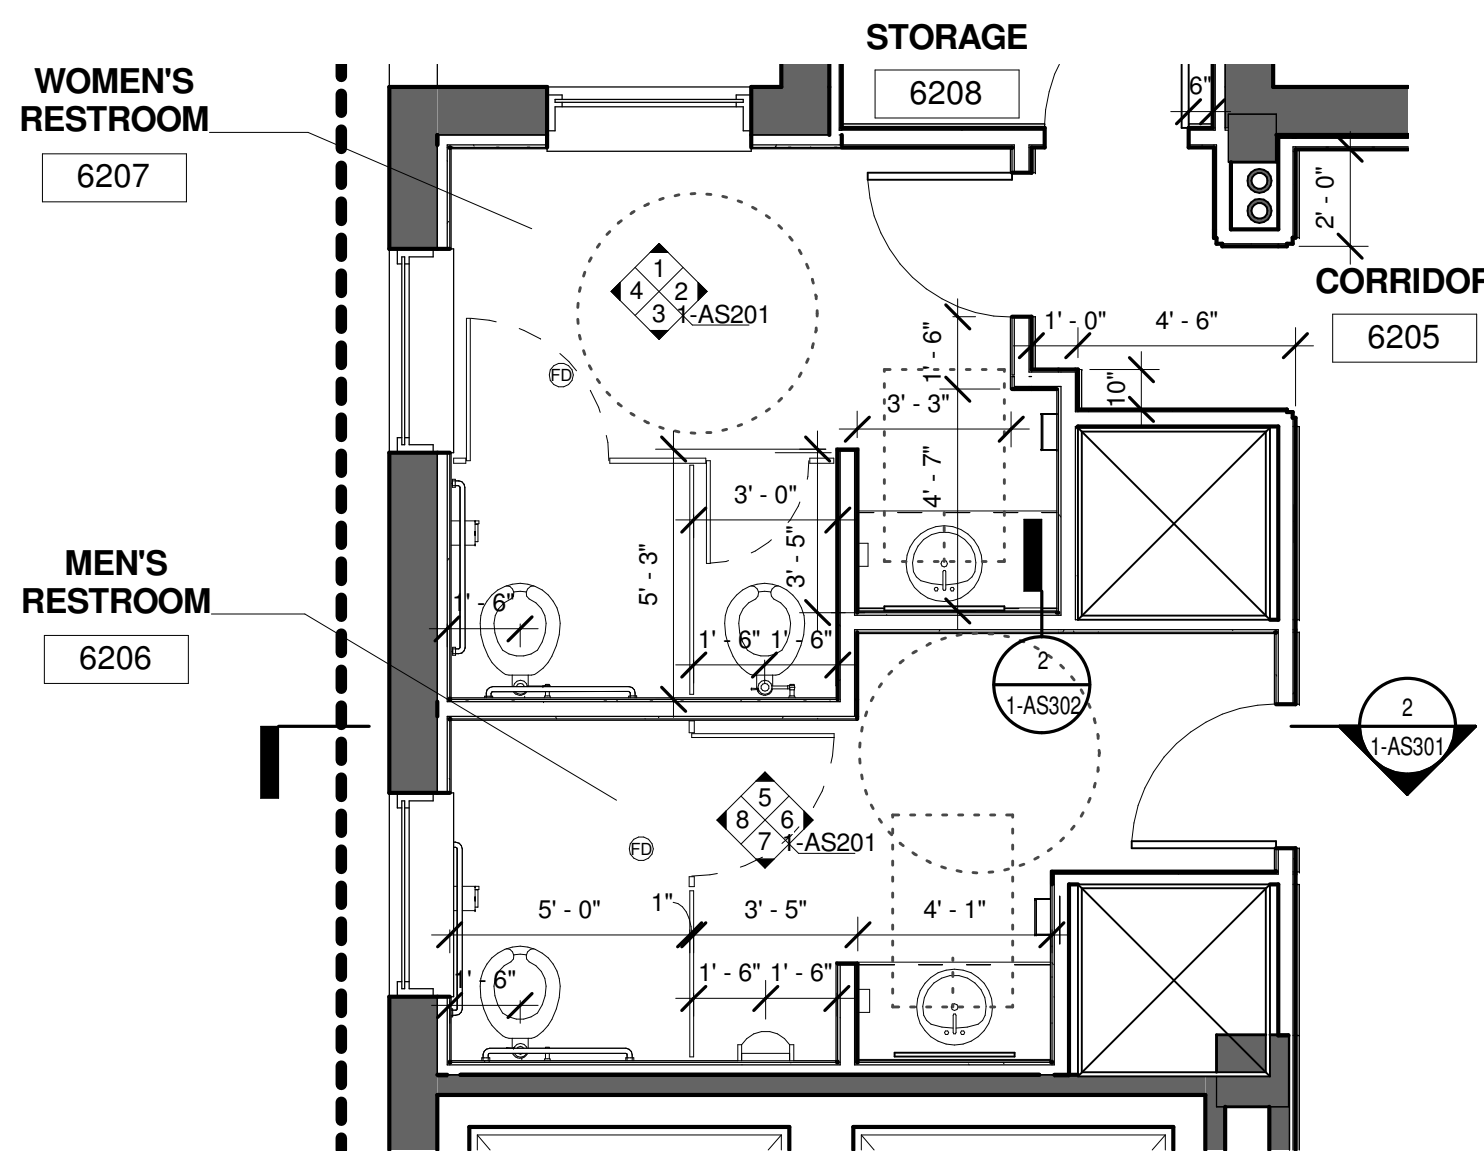


9201 West Broadway
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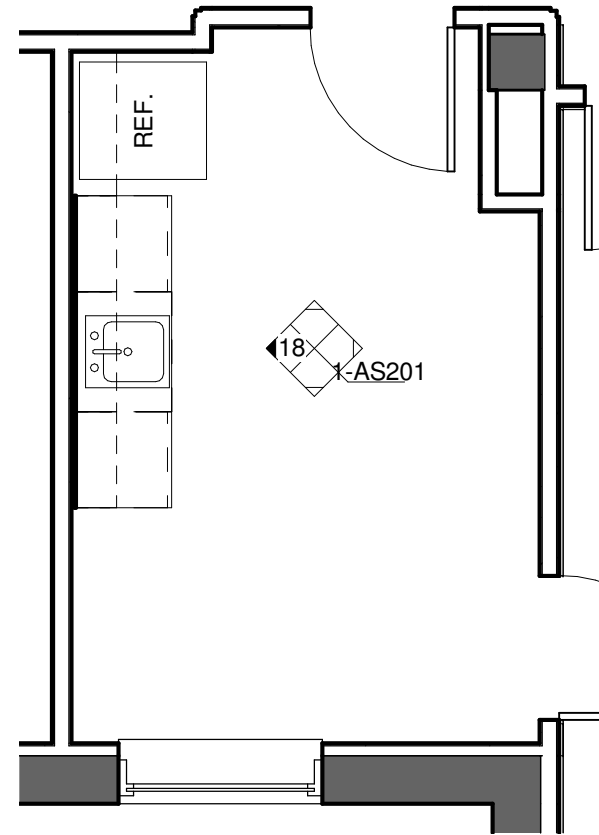
Approved: Medical Center Director	Approved: Safety Officer	Approved: Chief, EMS
Approved: Associate Director	Approved: Chief, IT	Approved: Chief, Infection Control
Approved: Chief, Facility Mgmt	Approved: Service Chief	Approved: Chief, Police

Project Name RENOVATE 6TH FLOOR			Project Number 575-12-102	
			Date 12 APRIL 2013	
			Drawing Number 1-AS108	
Building Number 1	Checked RHC	Drawn CAW	Dwg. of	


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B
one and one half inches = one foot
C
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D
three quarters inch = one foot
E
one half inch = one foot
F
three eighths inch = one foot
G
one quarter inch = one foot
H
one eighth inch = one foot




1 6TH FLOOR RESTROOM - ENLARGED FLOOR PLAN
SCALE: 1/4" = 1'-0" RE:1 /1-AS104



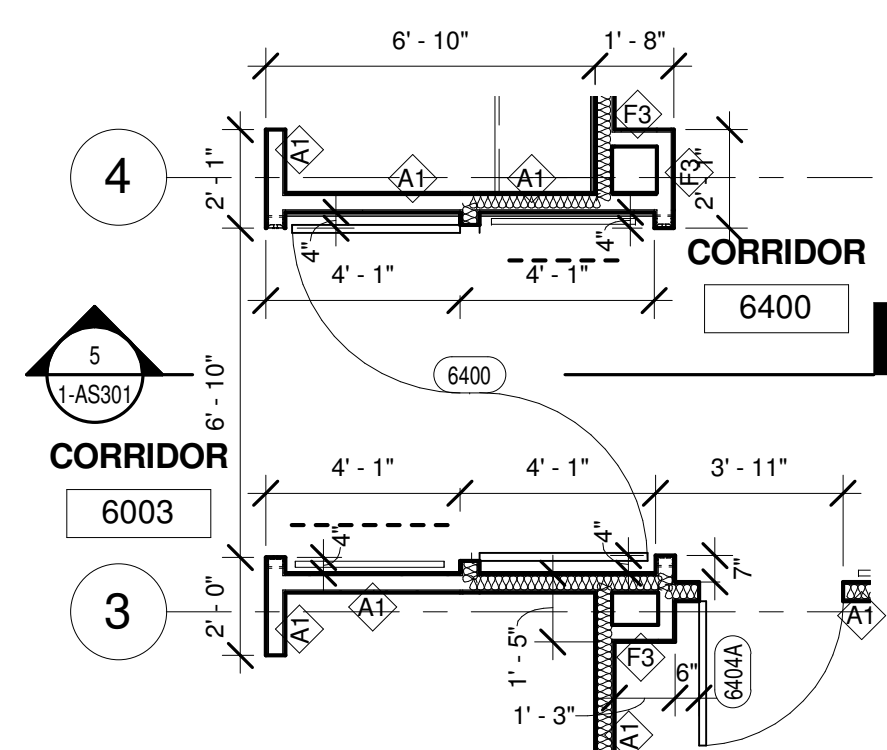2 6TH FLOOR KITCHENETTE - ENLARGED FLOOR PLAN
SCALE: 1/4" = 1'-0" RE:1 /1-AS104



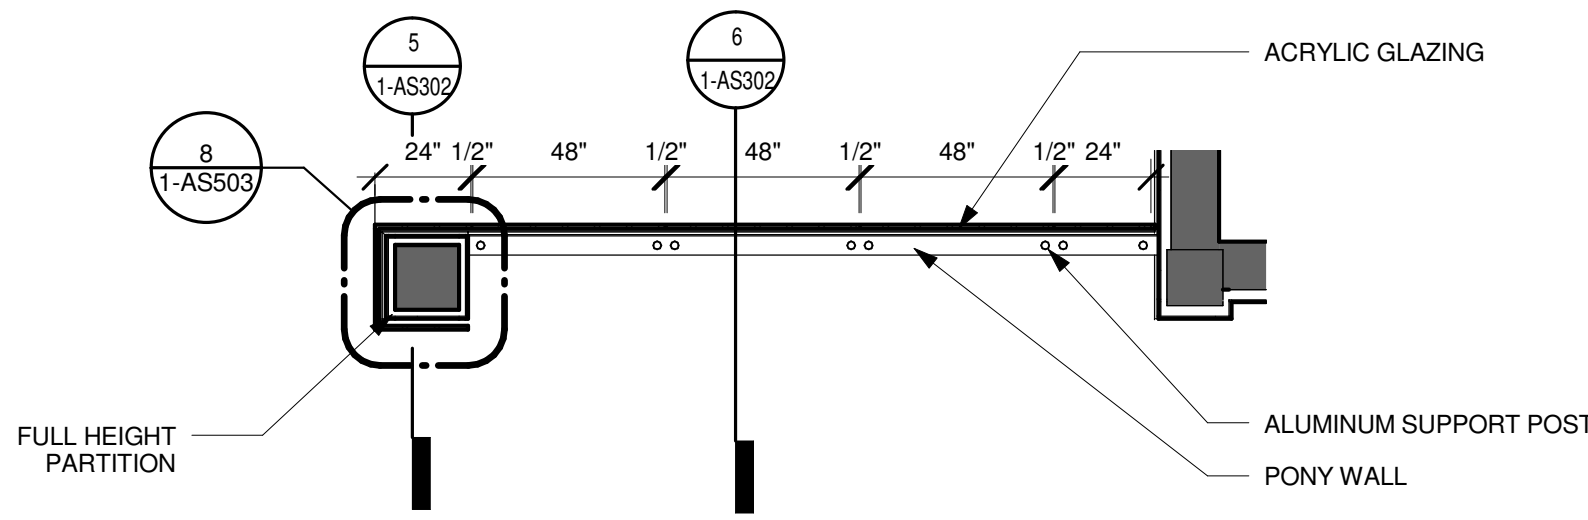3 CORRIDOR 6400 DOUBLE EGRESS ENLARGED PLAN DETAIL
SCALE: 1/4" = 1'-0" RE:1 /1-AS104



4 ENLARGED PLAN AT PRIVACY WALL
SCALE: 1/4" = 1'-0" RE:1 /1-AS104

GRAPHIC LEGEND

FLOOR PLAN - SYMBOLS LEGEND

	AREA IN CONTRACT		AREA NOT IN CONTRACT
	CONSTRUCTION LIMITS		MODULAR CASEWORK, SEE SHEET 1-CW1 & 1-CW2 FOR MODULAR CASEWORK, PROVIDED AND INSTALLED BY CONTRACTOR
	EXISTING WALL TO REMAIN		MILLWORK PROVIDED AND INSTALLED BY CONTRACTOR
	NEW WALL / PARTITION		PARTITION TYPE
	NEW DOOR		FLOOR DRAIN
	RECESSED FIRE EXTINGUISHER CABINET		ELECTRONIC KEY PAD LOCK
	ELECTRICAL PANEL		CONSTRUCTION LIMITS
	AUTOMATIC DOOR OPERATOR		IN-WALL SOUND ATTENUATION INSULATION
	CARD READER		

GYPSUM BOARD PARTITION SCHEDULE

SOUND PARTITION

- 1 3 5/8" STEEL STUDS @ 16" O.C. W/ 3" SOUND ATTENUATION INSULATION & 5/8" GYP BD @ EACH FACE. PROVIDE 1HR RATED UL # U465 DESIGN WHERE 1HR CONSTRUCTION IS INDICATED ON PLANS - SEE LIFE SAFETY PLANS
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GYPSUM BOARD PARTITION GENERAL NOTES

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- REFER TO GYP BD SPECIFICATION FOR LOCATIONS & TYPE(S) OF GYPSUM BOARD MATERIAL REQUIRED.
- PROVIDE TYPE "X" FIRE RATED GYPSUM BOARD AT ALL FIRE RATED PARTITIONS. SEAL ALL WALL PENETRATIONS AT PERIMETER AND FIRESTOP ALL FIRE RATED PARTITIONS.
- REFERENCE "LIFE SAFETY PLANS" FOR WALL RATINGS
- NOISE TRANSMISSION CONTROL PROVIDED IN ALL OFFICES


SHEET NOTES

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BUILDING IS FULLY SPRINKLERED

Revisions:	Date:	12 APRIL 2013	CONSULTANTS:	ARCHITECT/ENGINEERS:	Approved: Medical Center Director	Approved: Safety Officer	Approved: Chief, EMS	Drawing Title	Project Name	Project Number	Office of Construction and Facilities Management			
			SSR Smith Beckman Red, Inc.	COX DESIGN ASSOCIATES	Approved: Associate Director	Approved: Chief, IT	Approved: Chief, Infection Control	6TH FLOOR - ENLARGED FLOOR PLAN	RENOVATE 6TH FLOOR	575-12-102	Department of Veterans Affairs			
			9201 West Broadway Brooklyn Park, MN 55445 Tel: 763.315.7600 Fax: 763.315.7920	ARCHITECTURE PLANNING INTERIORS Austin 5121 Bee Caves Road, Suite 203 Austin, Texas 78746 T:512 - 327 - 4149 F:512 - 327 - 7679 coxdesign@austin.rr.com	Approved: Chief, Facility Mgmt	Approved: Service Chief	Approved: Chief, Police	Location GRAND JUNCTION VAMC 2121 NORTH AVENUE GRAND JUNCTION, CO 81501	Building Number 1	Checked RHC	Drawn CAW	Date 12 APRIL 2013	Drawing Number 1-AS109	Dwg. of

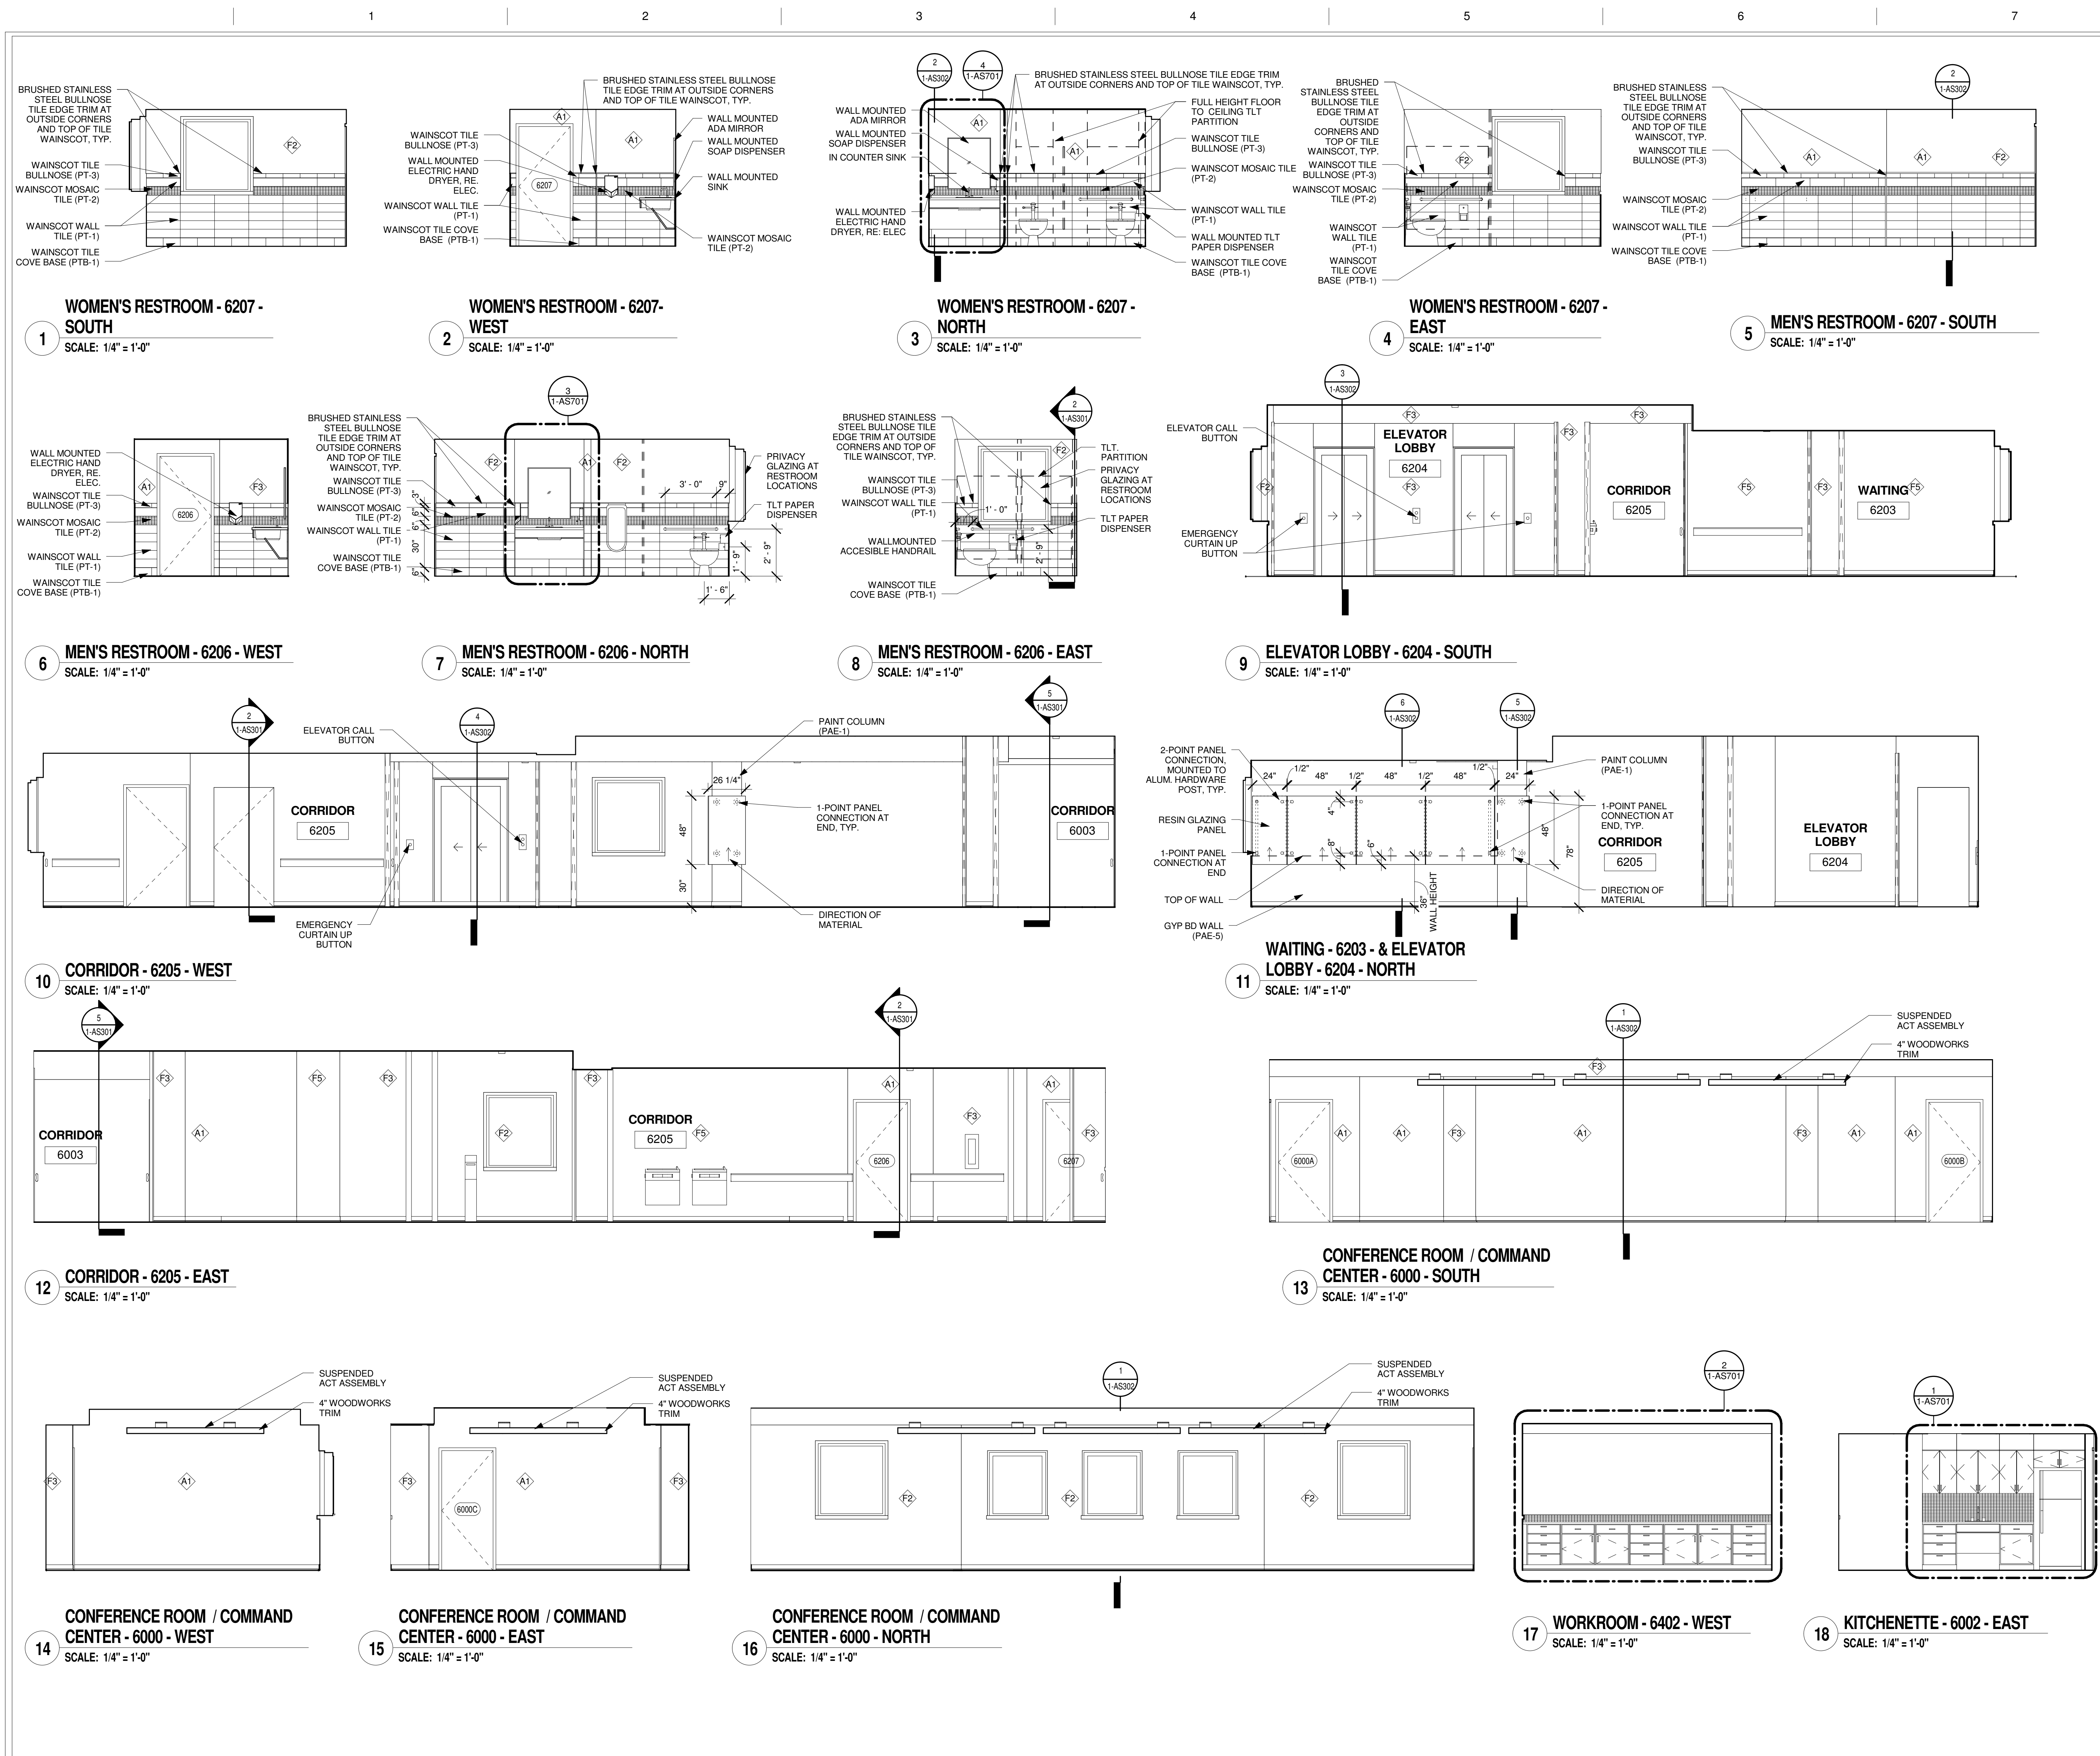A
three inches = one foot
B
one and one half inches = one foot
C
one inch = one foot
D
one half inch = one foot
E
three eighths inch = one foot
F
one quarter inch = one foot
one eighth inch = one foot



KEY NOTES

GYPSUM BOARD PARTITION SCHEDULE
SOUND PARTITION
A1 3 5/8" STEEL STUDS @ 16" O.C. W/ 3" SOUND ATTENUATION INSULATION & 5/8" GYP BD @ EACH FACE. PROVIDE 1HR RATED UL # U465 DESIGN WHERE 1HR CONSTRUCTION IS INDICATED ON PLANS - SEE LIFE SAFETY PLANS
A2 6" STEEL STUDS @ 16" O.C. W/ 6" SOUND ATTENUATION INSULATION & 5/8" GYP BD @ EACH FACE. PROVIDE 1HR RATED UL # U465 DESIGN WHERE 1HR CONSTRUCTION IS INDICATED ON PLANS - SEE LIFE SAFETY PLANS
FURRING
F DIRECT BONDED 5/8" GYP BD
F1 1 5/8" STEEL STUDS @ 16" OC W/ 5/8" GYP BD
F2 2 1/2" STEEL STUDS @ 16" OC W/ 5/8" GYP BD
F3 3 5/8" STEEL STUDS @ 16" OC W/ 5/8" GYP BD
F4 3 5/8" STEEL STUDS @ 16" OC W/ 3" SOUND ATTENUATION INSULATION & 5/8" GYP BD
F5 7/8" STEEL HAT CHANNEL @ 16" OC W/ 5/8" GYP BD
GYPSUM BOARD PARTITION GENERAL NOTES
1. ALL GYP BD PARTITIONS SHALL BE A1 UNLESS OTHERWISE NOTED ON FLOOR PLANS
2. GYP BD PARTITION DIMENSIONS ON FLOOR PLAN ARE BASED ON FACE OF FINISHED PARTITION TO FACE OF FINISHED PARTITION (NOMINAL).
3. REFER TO GYP BD SPECIFICATION FOR LOCATIONS & TYPE(S) OF GYPSUM BOARD MATERIAL REQUIRED.
4. PROVIDE TYPE "X" FIRE RATED GYPSUM BOARD AT ALL FIRE RATED PARTITIONS.
5. SEAL ALL WALL PENETRATIONS AT PERIMETER AND FIRESTOP ALL FIRE RATED PARTITIONS.
6. REFERENCE "LIFE SAFETY PLANS" FOR WALL RATINGS
7. NOISE TRANSMISSION CONTROL PROVIDED IN ALL OFFICES

SHEET NOTES

INTERIOR ELEVATION NOTES:
A SEE PROJECT FINISH REFERENCE, SHEET 1-AS601 FOR FINISHES, MATERIALS, AND COLORS FOR: WALLS, DOOR, WALL PROTECTION DEVICES, HANDRAILS, BASE, TILE, AND GROUT.
B REFER TO SHEET 1-AS503 FOR ALL MOUNTING HEIGHTS
C REFER TO SHEET 1-AS701 FOR MILLWORK
D HANDRAIL TO BE NO LESS THAN 13-7/8" IN LENGTH.

BUILDING IS FULLY SPRINKLERED

Project Name RENOVATE 6TH FLOOR		Project Number 575-12-102	
		Date 12 APRIL 2013	
Building Number 1		Checked RHC	Drawn CAW
Drawing Title 6TH FLOOR - INTERIOR ELEVATIONS		Drawing Number 1-AS201	
Location GRAND JUNCTION VAMC 2121 NORTH AVENUE GRAND JUNCTION, CO 81501		Dwg. of	

Office of Construction and Facilities Management
Department of Veterans Affairs

Revisions:
Date

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Approved: Medical Center Director	Approved: Safety Officer	Approved: Chief, EMS
Approved: Associate Director	Approved: Chief, IT	Approved: Chief, Infection Control
Approved: Chief, Facility Mgmt	Approved: Service Chief	Approved: Chief, Police

Drawing Title 6TH FLOOR - INTERIOR ELEVATIONS	
Location GRAND JUNCTION VAMC 2121 NORTH AVENUE GRAND JUNCTION, CO 81501	

1 BUILDING SECTION AT THE WEST END OF CORRIDOR 6003
SCALE: 3/16" = 1'-0" RE:1/1

2 BUILDING SECTION AT THE RESTROOMS
SCALE: 3/16" = 1'-0" RE:1/1

3 BUILDING SECTION AT THE EAST END OF CORRIDOR 6400
SCALE: 3/16" = 1'-0" RE:1 / 1

4 BUILDING SECTION AT STORAGE
SCALE: 3/16" = 1'-0" RE:1 /1

5 BUILDING SECTION AT CORRIDOR 6003 & 6400
SCALE: 3/16" = 1'-0" RE:1/1

KEY NOTES

GYPSUM BOARD PARTITION SCHEDULE

SOUND PARTITION

- A1) 3 5/8" STEEL STUDS @ 16" O.C. W/ 3" SOUND ATTENUATION INSULATION & 5/8" GYP BD @ EACH FACE. PROVIDE 1HR RATED UL # U465 DESIGN WHERE 1HR CONSTRUCTION IS INDICATED ON PLANS - SEE LIFE SAFETY PLANS
- A2) 6" STEEL STUDS @ 16" O.C. W/ 6" SOUND ATTENUATION INSULATION & 5/8" GYP BD @ EACH FACE. PROVIDE 1HR RATED UL # U465 DESIGN WHERE 1HR CONSTRUCTION IS INDICATED ON PLANS - SEE LIFE SAFETY PLANS

FURRING

F DIRECT BONDED 5/8" GYP BD

F3 3 5/8" STEEL STUDS @ 16" OC W/ 5/8" GYP
BD

F1 1 5/8" STEEL STUDS @ 16" OC W/ 5/8" GYP BD

④ F4 3 5/8" STEEL STUDS @ 16" OC W/ 3" SOUND

ATTENUATION INSULATION & 5/8" GYP BD

◇ F5 7/8" STEEL HAT CHANNEL @ 16" OC W/ 5/8"
GYP BD


GYPSUM BOARD PARTITION GENERAL NOTES

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5. REFERENCE "LIFE SAFETY PLANS" FOR WALL RATINGS
6. NOISE TRANSMISSION CONTROL PROVIDED IN ALL OFFICES

SHEET NOTES


A. SEAL ALL WALL PENETRATIONS

**BUILDING IS
FULLY
SPRINKLERED**


Project Name RENOVATE 6TH FLOOR			Project Number 575-12-102		<div>Office of Construction and Facilities Management</div> <div>  Department of Veterans Affairs </div>
			Date 12 APRIL 2013		
			Drawing Number 1-AS301		
Building Number 1	Checked RHC	Drawn CAW	Dwg. of		

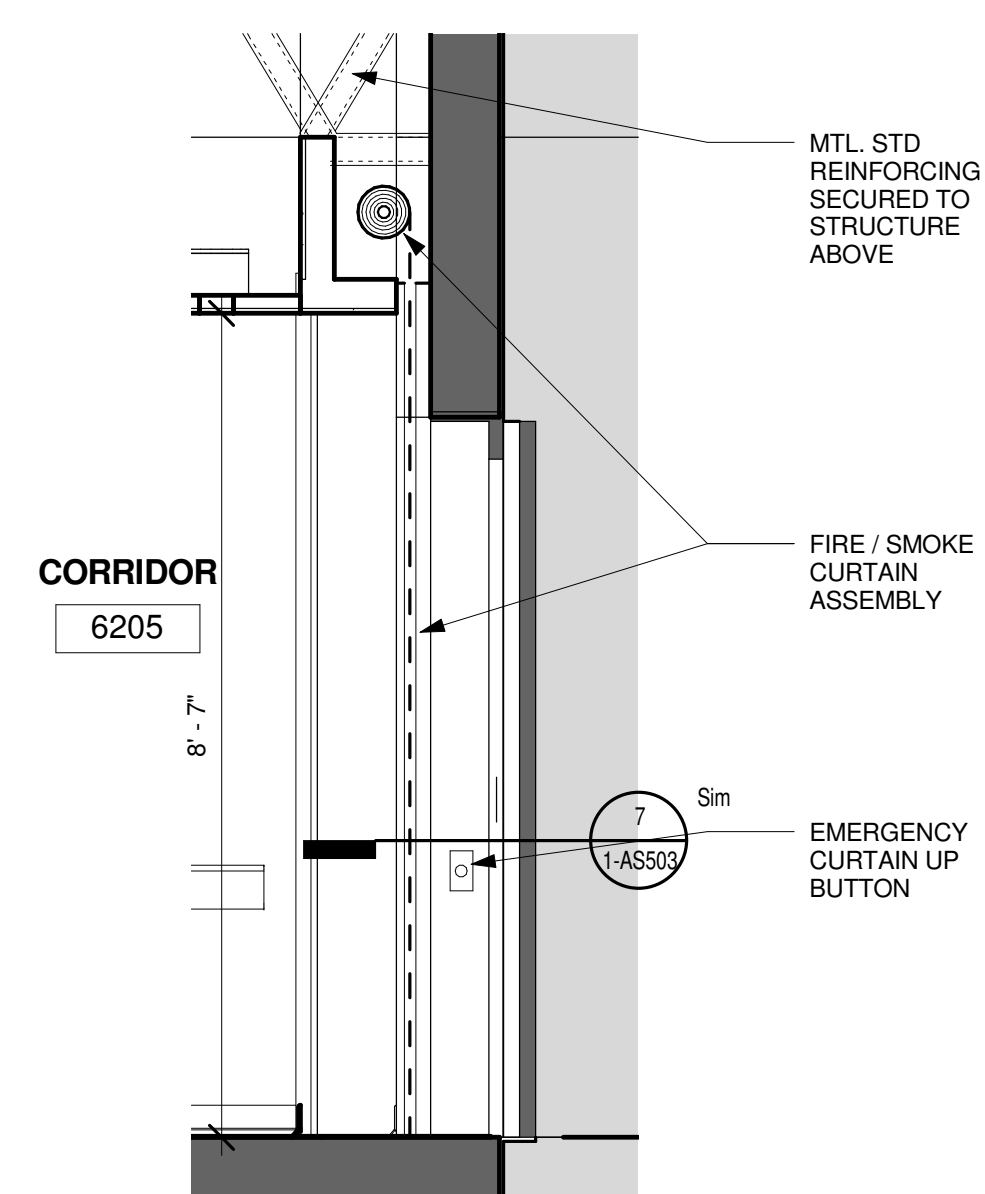Office of
Construction
and Facilities
Management





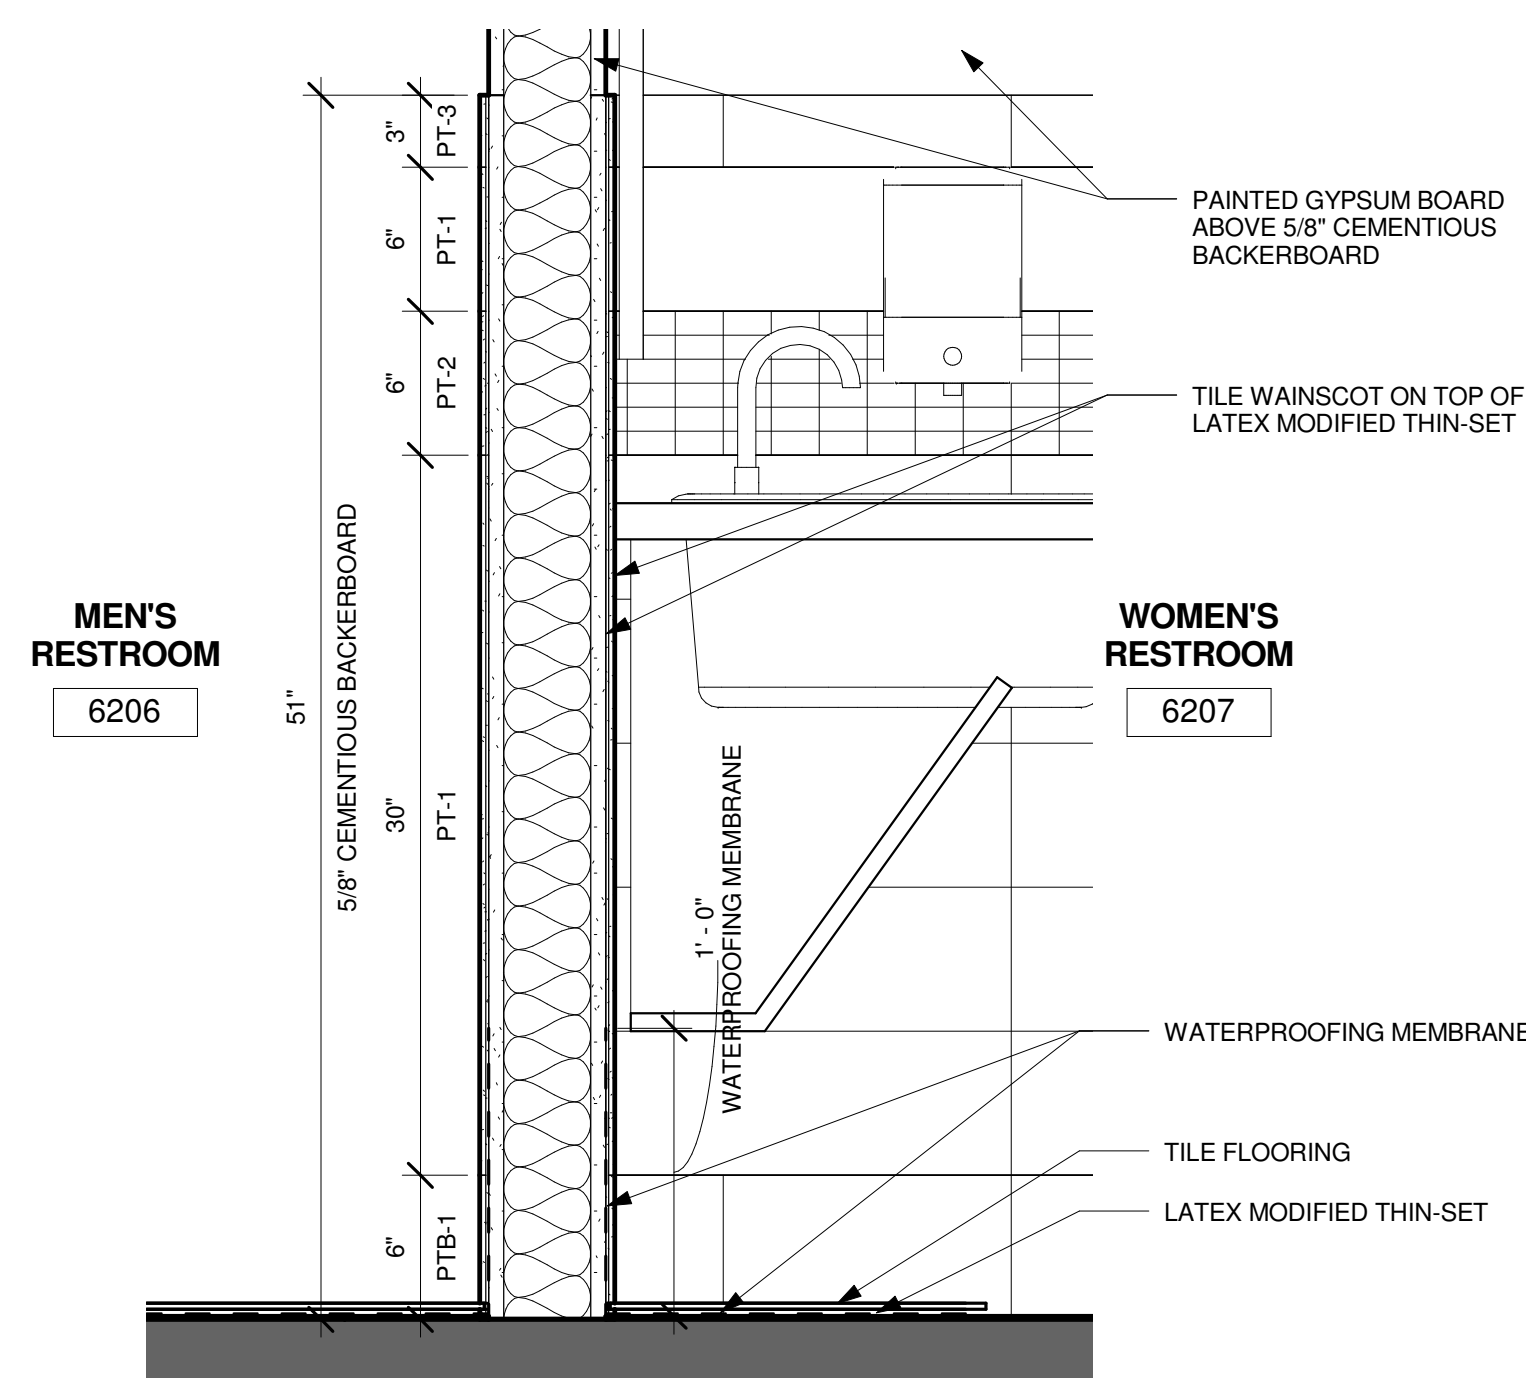4 TYPICAL SECTION AT SERVICE ELEVATOR
SCALE: 1/2" = 1'-0" RE:3 /1-AS108



7 RESTROOM WAINSCOT DETAIL
SCALE: 1 1/2" = 1'-0" RE:2 /1-AS302

**BUILDING IS
FULLY
SPRINKLERED**



Approved: Medical Center Director	Approved: Safety Officer	Approved: Chief, EMS
Approved: Associate Director	Approved: Chief, IT	Approved: Chief, Infection Control
Approved: Chief, Facility Mgmt	Approved: Service Chief	Approved: Chief, Police

Drawing Title	SECTIONS
Location	GRAND JUNCTION VAMC 2121 NORTH AVENUE GRAND JUNCTION, CO 81501

Project Name **RENOVATE 6TH FLOOR**

Project Number
575-12-102

Date
12 APRIL 2013

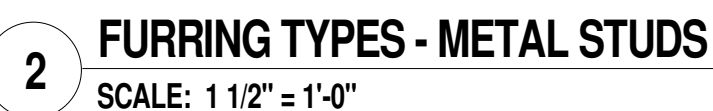
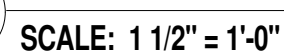
	Drawing Number

1-AS302

Office of
Construction
and Facilities
Management



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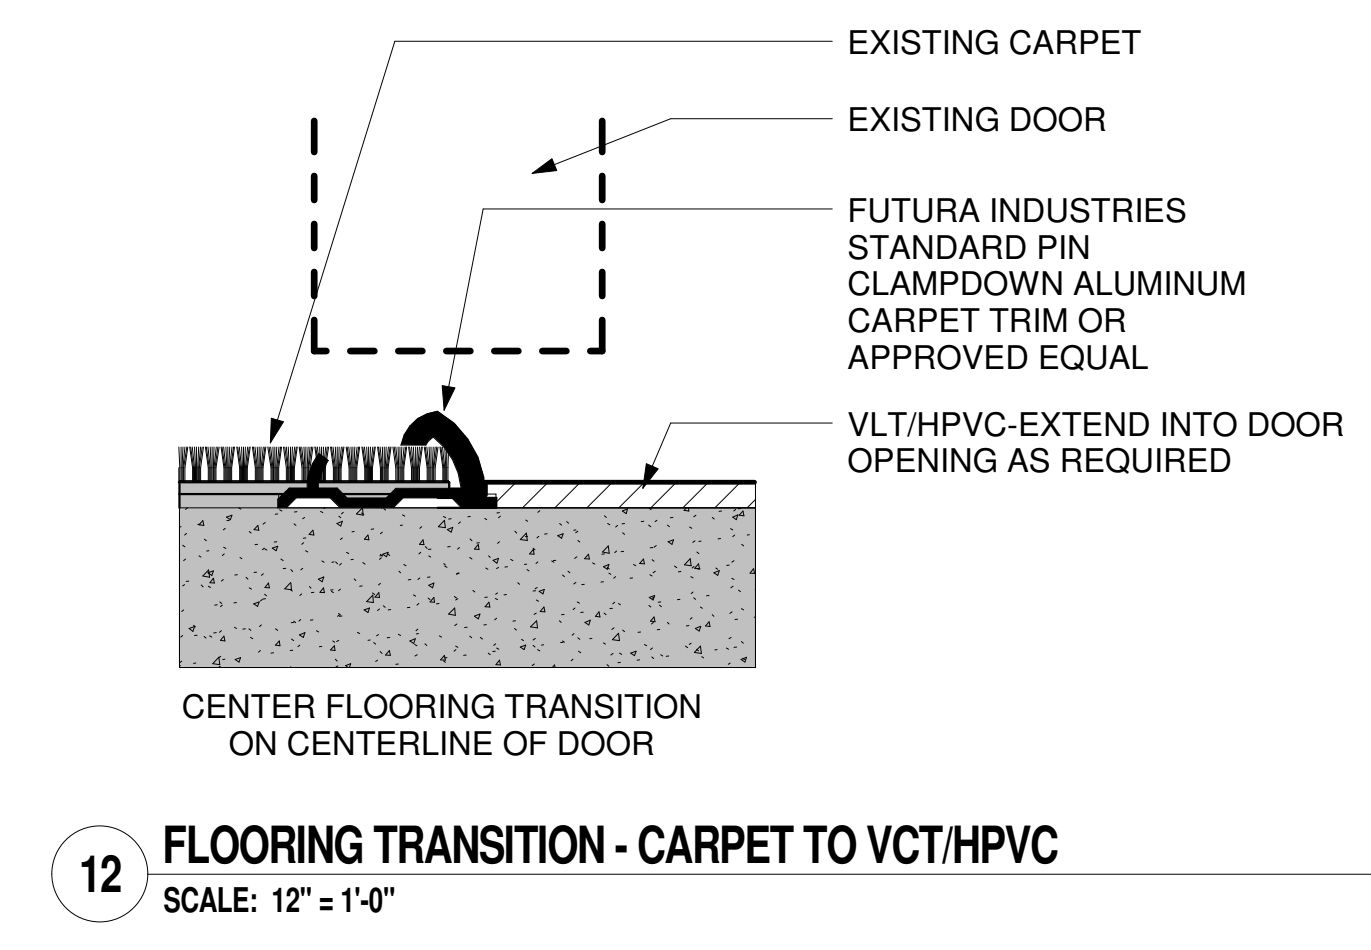
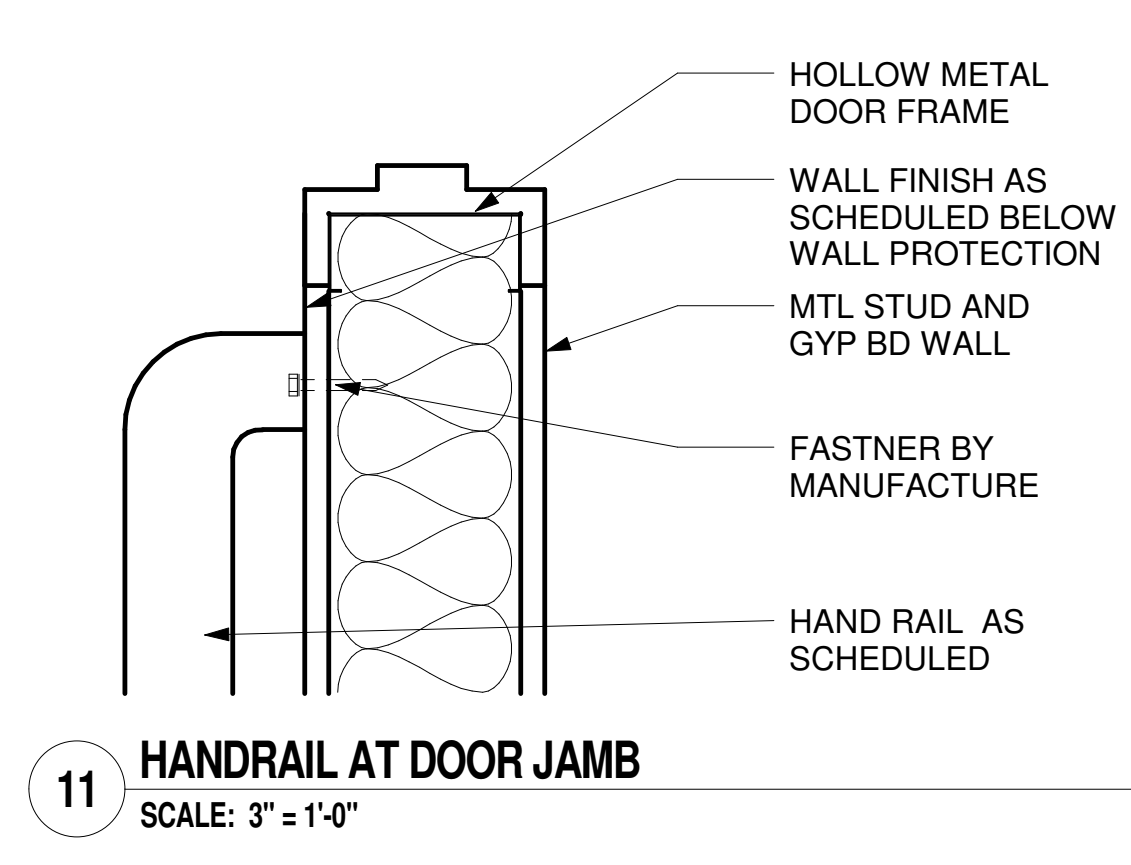
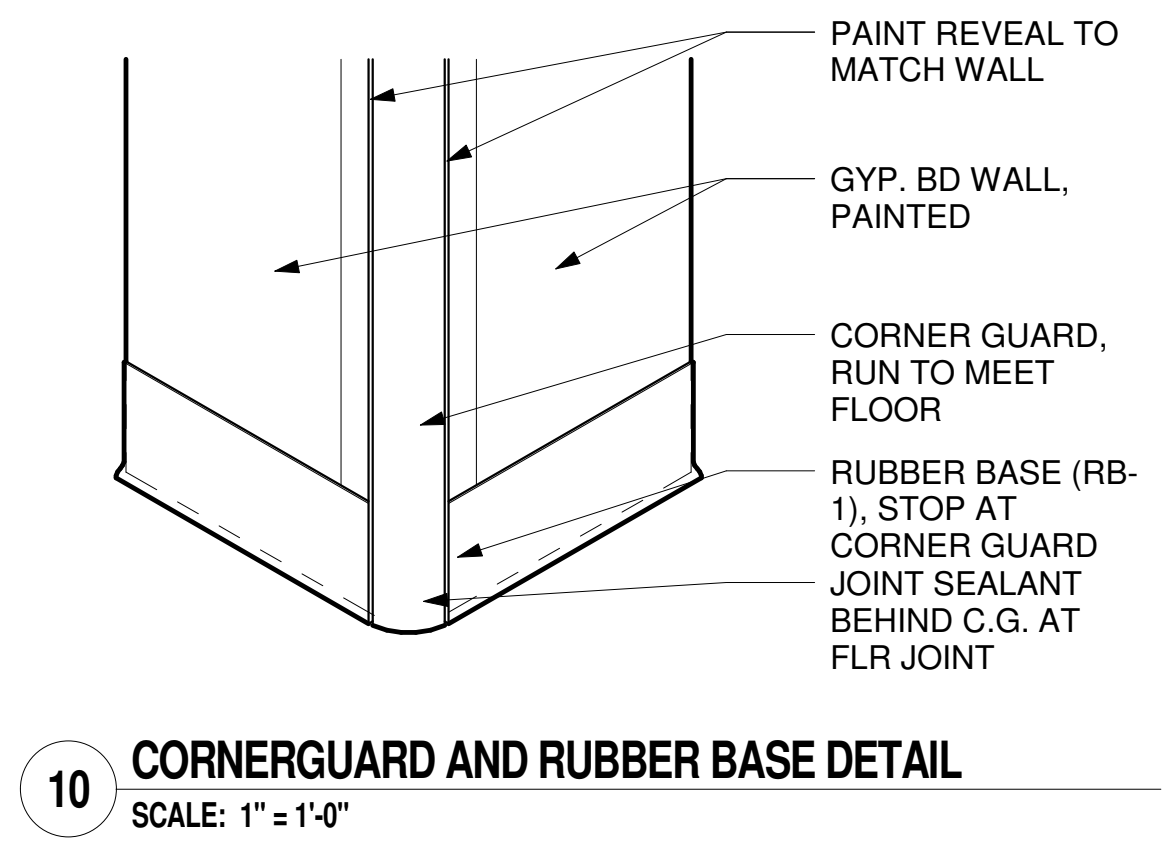
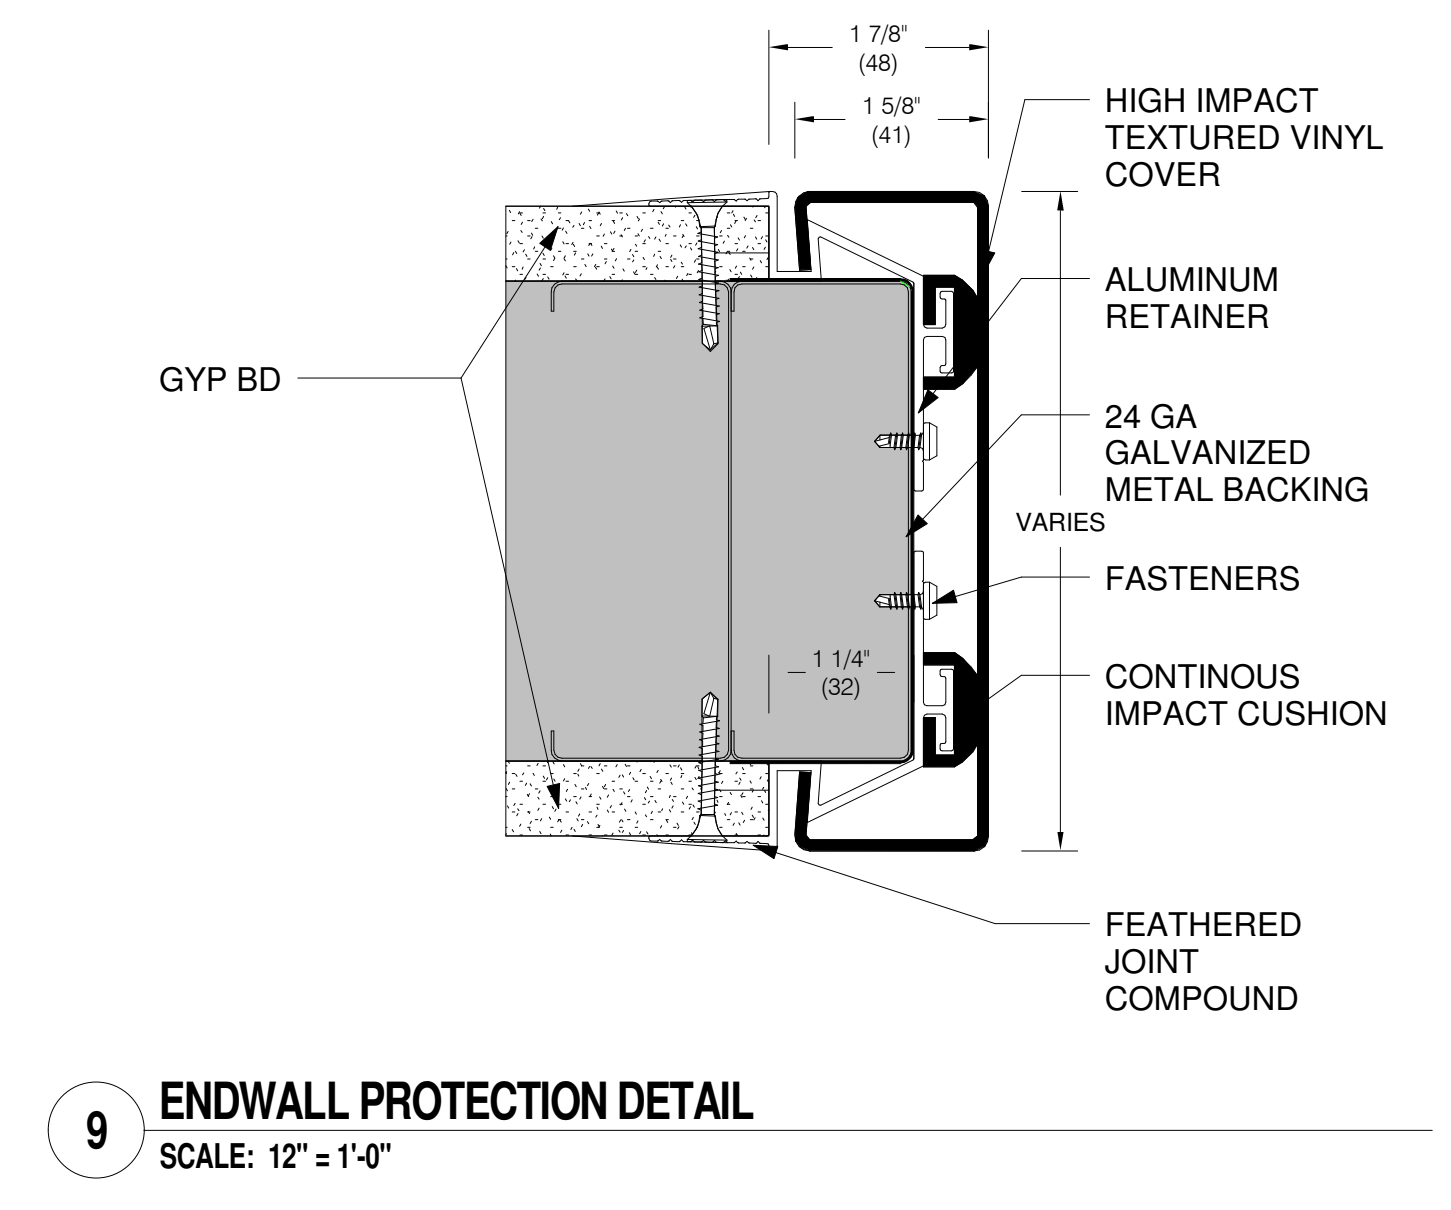
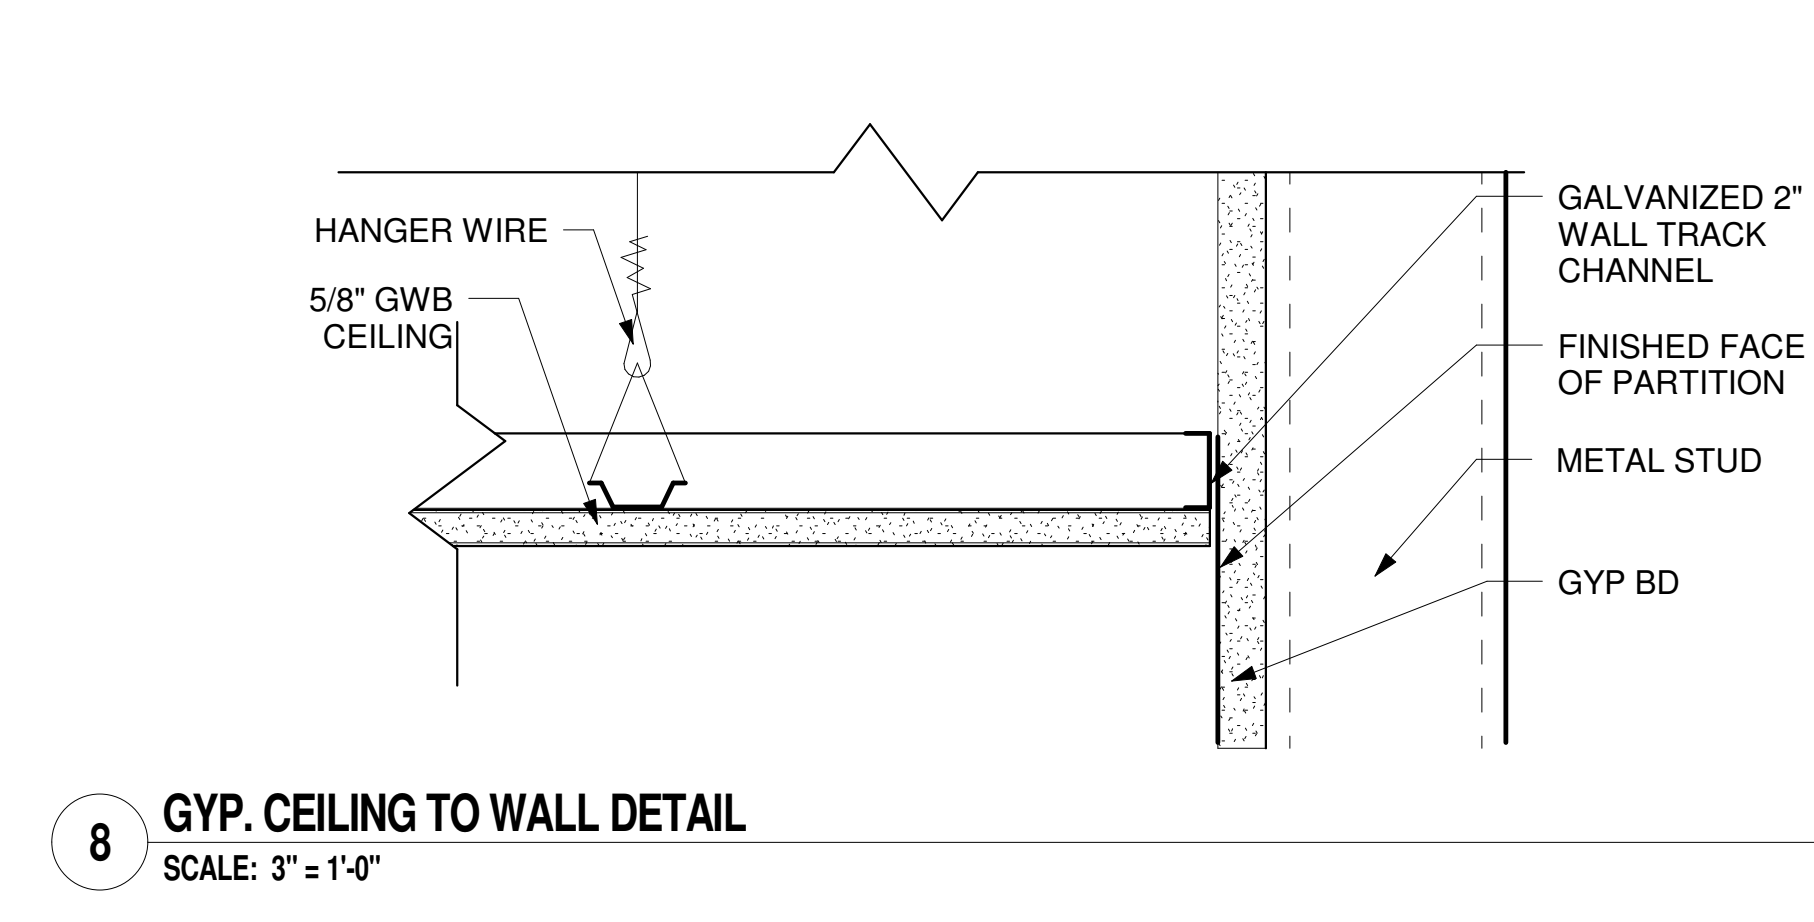
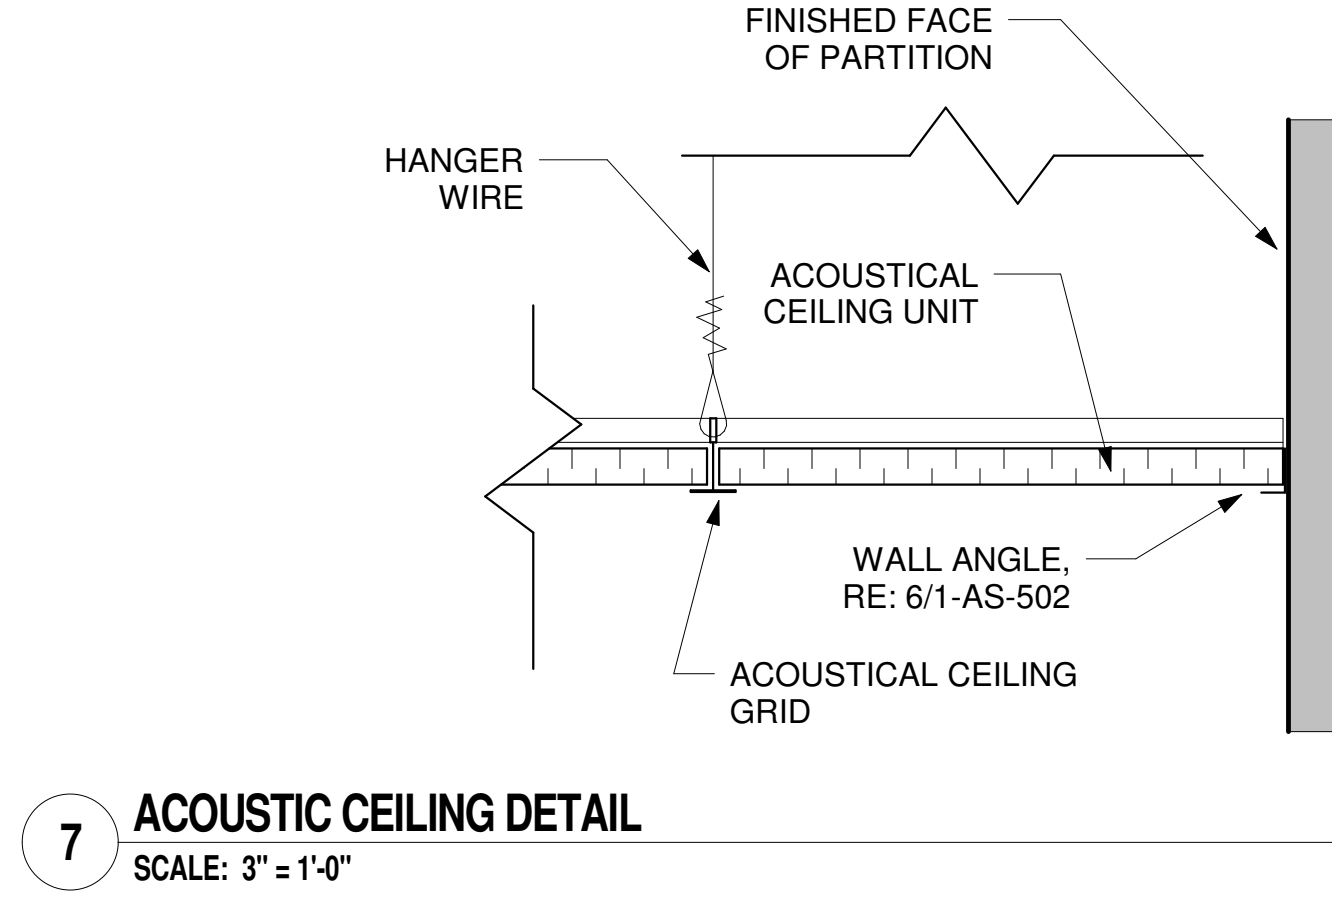
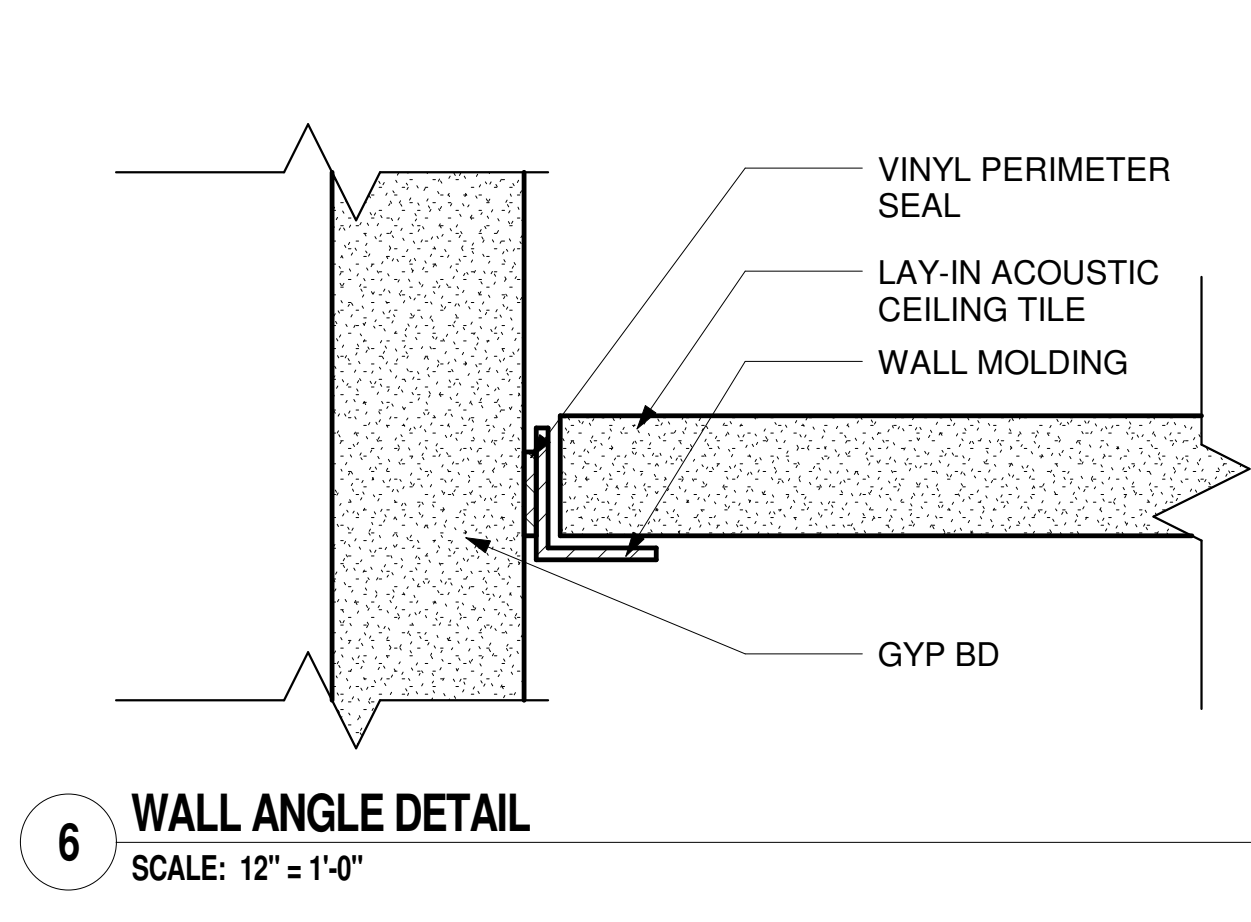
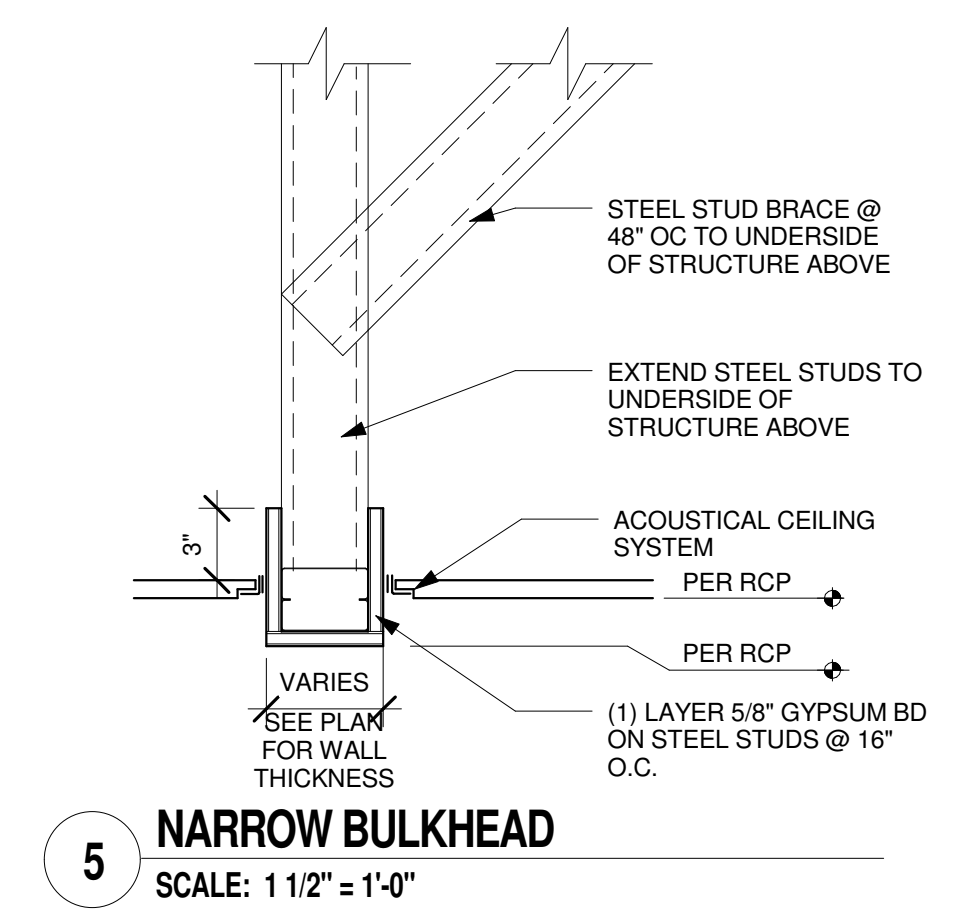
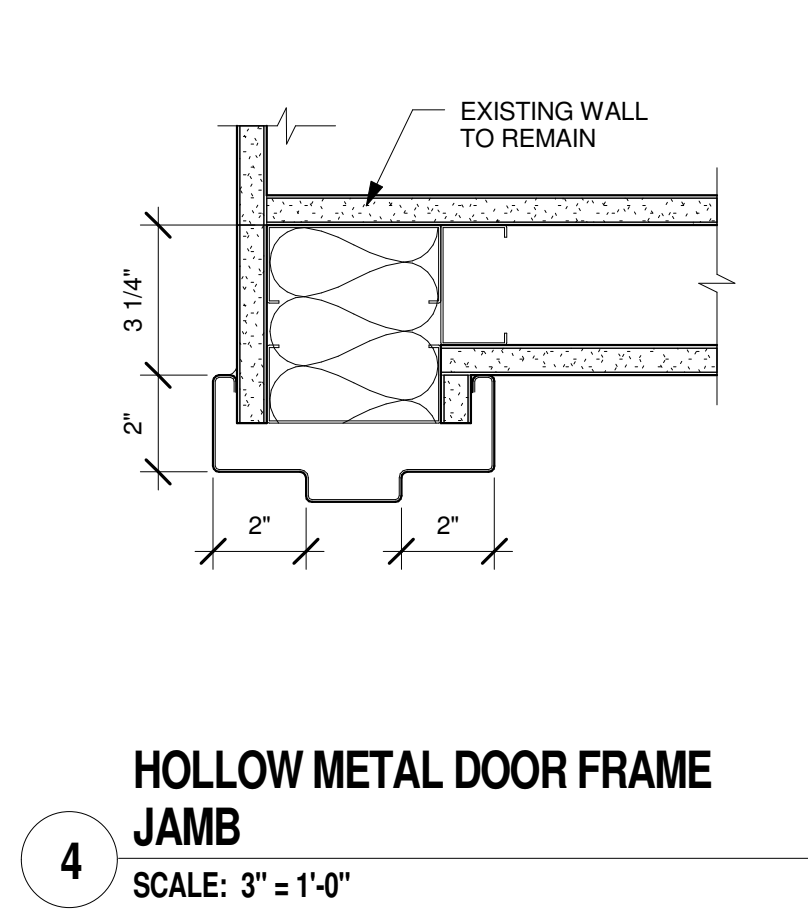
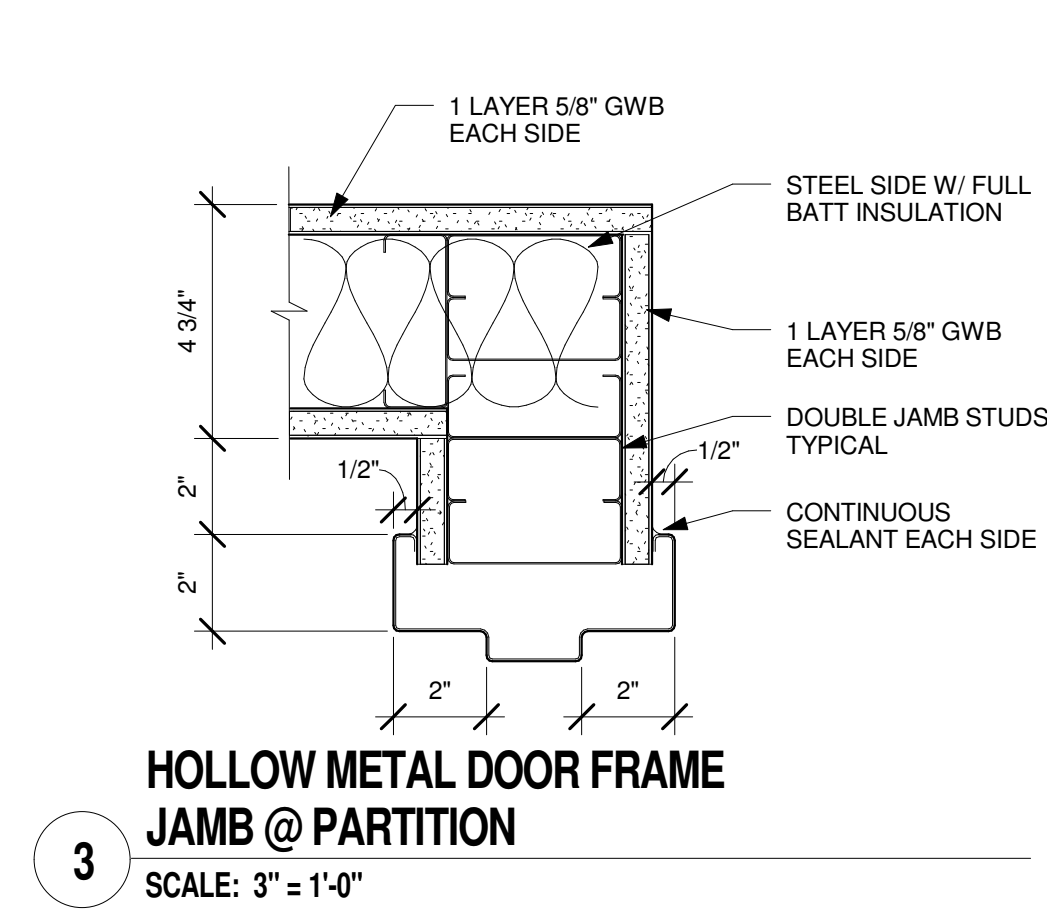
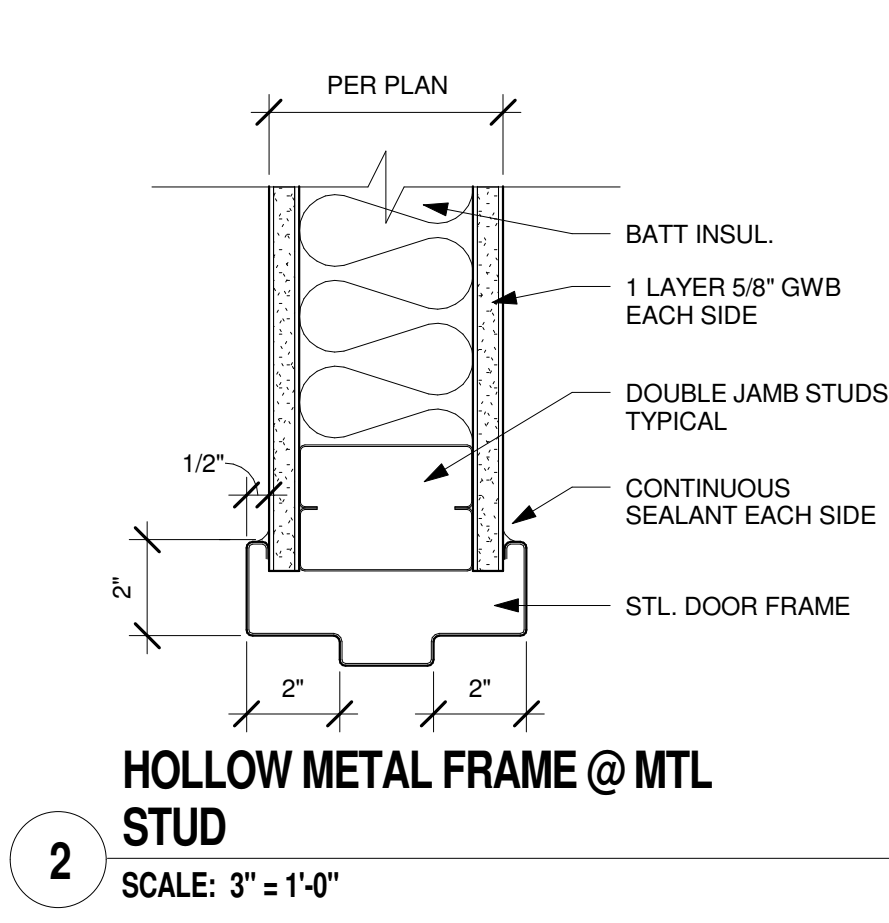
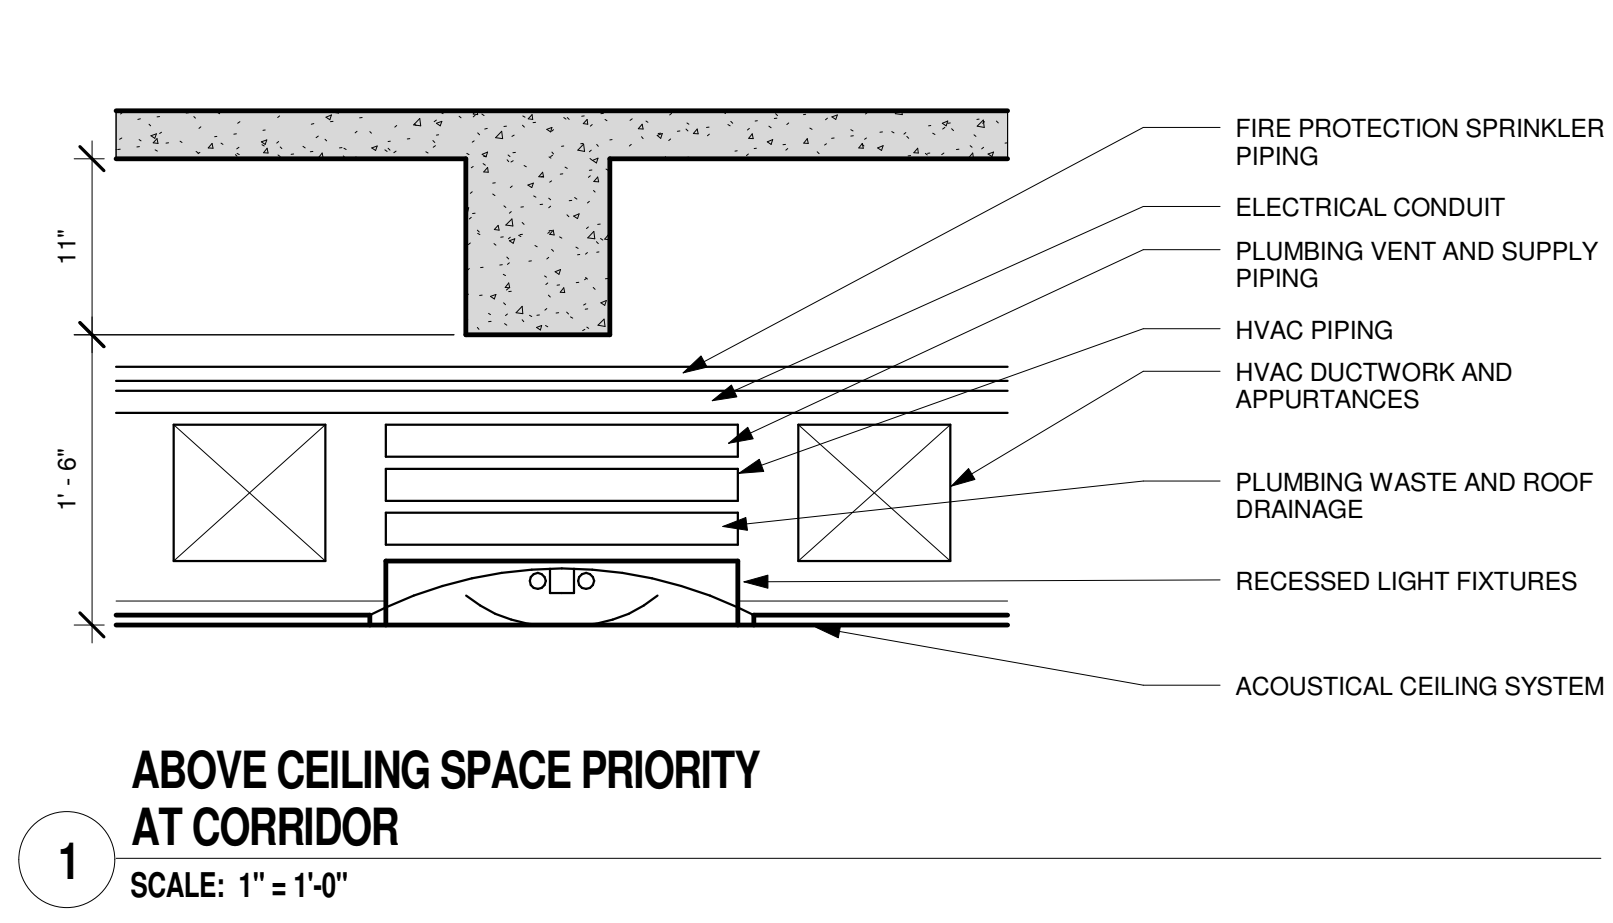


BUILDING IS FULLY SPRINKLERED

Department of
Veterans Affairs

A
B
C
D
E
F

three inches = one foot
one and one half inches = one foot
one inch = one foot
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one half inch = one foot
three eighths inch = one foot
one quarter inch = one foot
one eighth inch = one foot
one sixteenth inch = one foot




BUILDING IS FULLY SPRINKLERED


Drawing Title ARCHITECTURAL DETAILS		Project Name RENOVATE 6TH FLOOR		Project Number 575-12-102	
Location GRAND JUNCTION VAMC 2121 NORTH AVENUE GRAND JUNCTION, CO 81501		Building Number 1		Checked RHC	Drawn CAW
Date 12 APRIL 2013		Drawing Number 1-AS502		Dwg. of	

Office of Construction and Facilities Management
Department of Veterans Affairs


Revisions:	Date	 CONSULTANTS: 9201 West Broadway Brooklyn Park, MN 55445 Tel: 763.315.7600 Fax: 763.315.7920	 Smith Seckman Reid, Inc. 8055 E. Taffin Ave. Suite 1100 Denver, CO 80231 (303) 778-1222 FAX: (303) 694-9144 www.ssr-inc.com	ARCHITECT/ENGINEERS: COX DESIGN ASSOCIATES ARCHITECTURE PLANNING INTERIORS Austin 5121 Bee Caves Road, Suite 203 Austin, Texas 78746 Chicago 345 N. Canal St. Suite 701 Chicago, IL 60605 T: 512 - 327 - 4149 F: 512 - 327 - 7679 T: 312 - 454 - 9434 F: 312 - 454 - 9439 coxdesign@austin.rr.com bcox@coxtd.com	Approved: Medical Center Director Approved: Associate Director Approved: Chief, Facility Mgmt	Approved: Safety Officer Approved: Chief, IT Approved: Service Chief	Approved: Chief, EMS Approved: Chief, Infection Control Approved: Chief, Police	Drawing Title ARCHITECTURAL DETAILS			Project Name RENOVATE 6TH FLOOR		Project Number 575-12-102							
									Location GRAND JUNCTION VAMC 2121 NORTH AVENUE GRAND JUNCTION, CO 81501		Building Number 1		Checked RHC	Drawn CAW	Date 12 APRIL 2013		Drawing Number 1-AS502		Dwg. of	

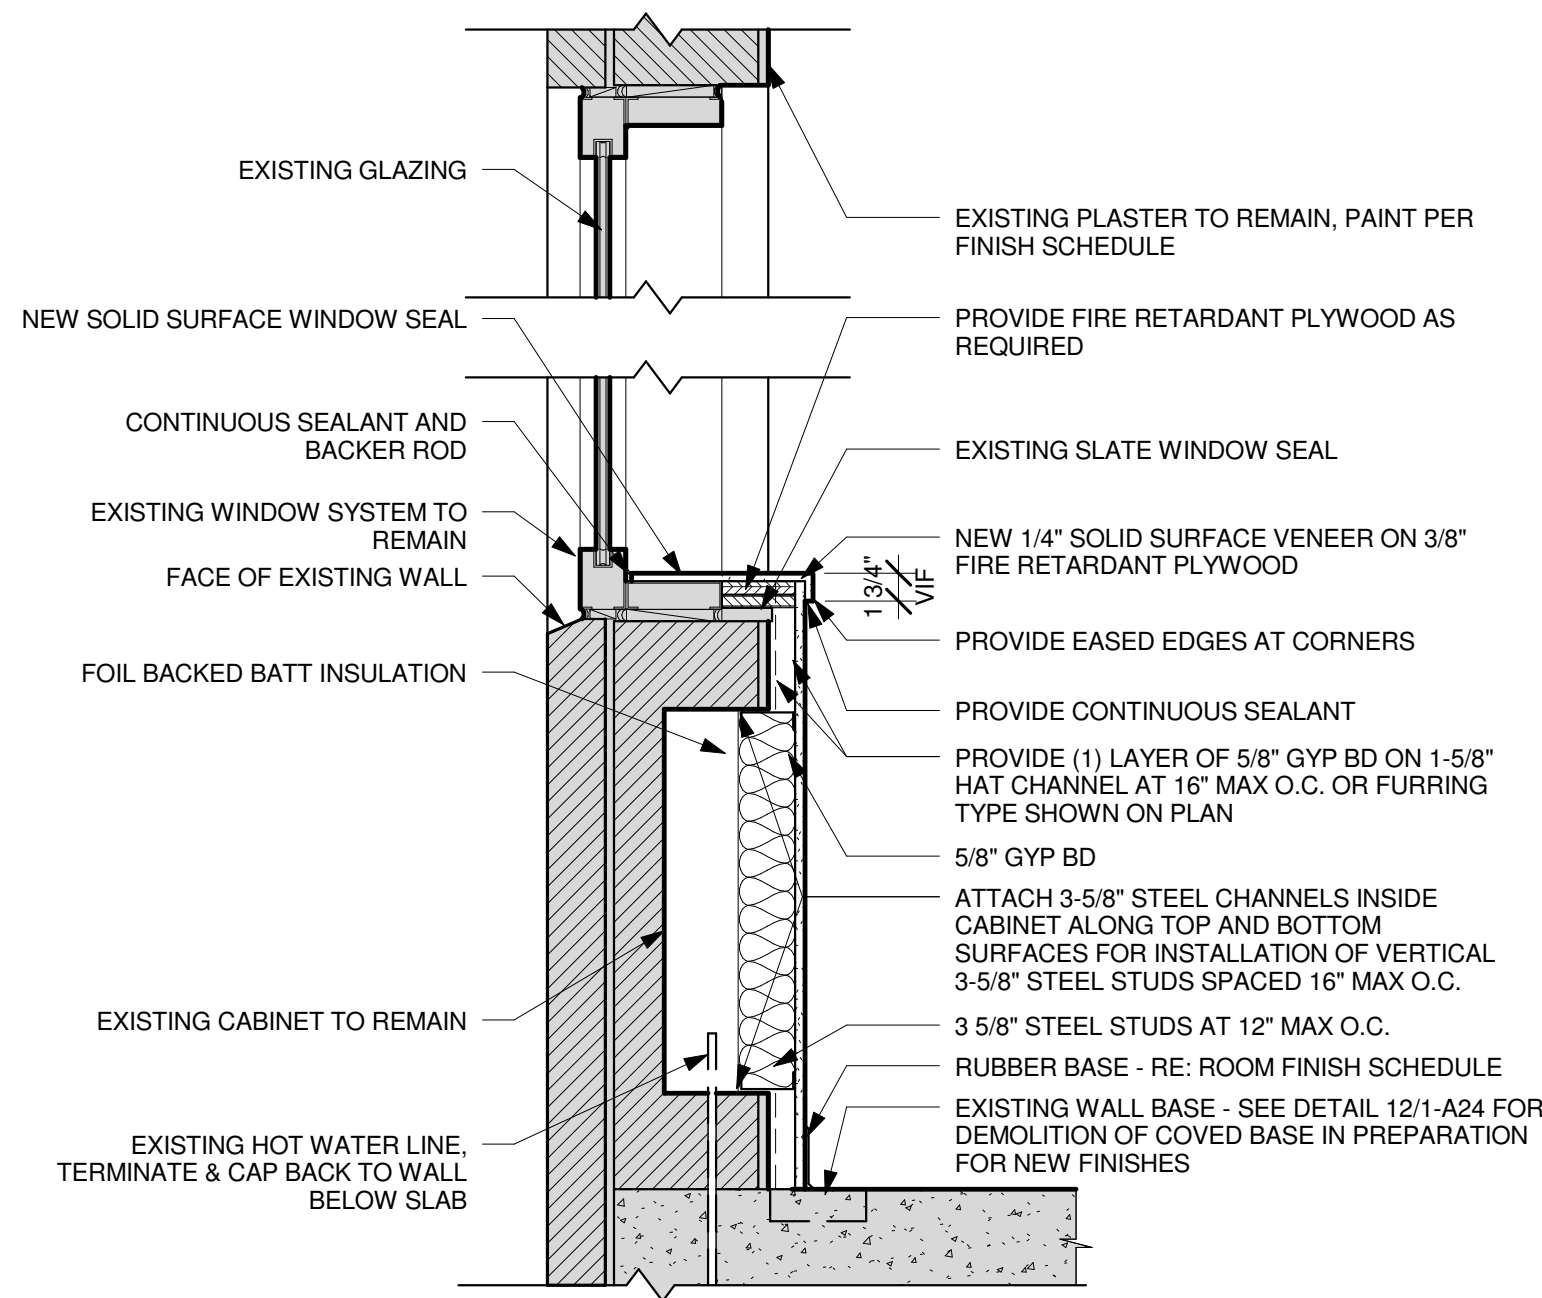

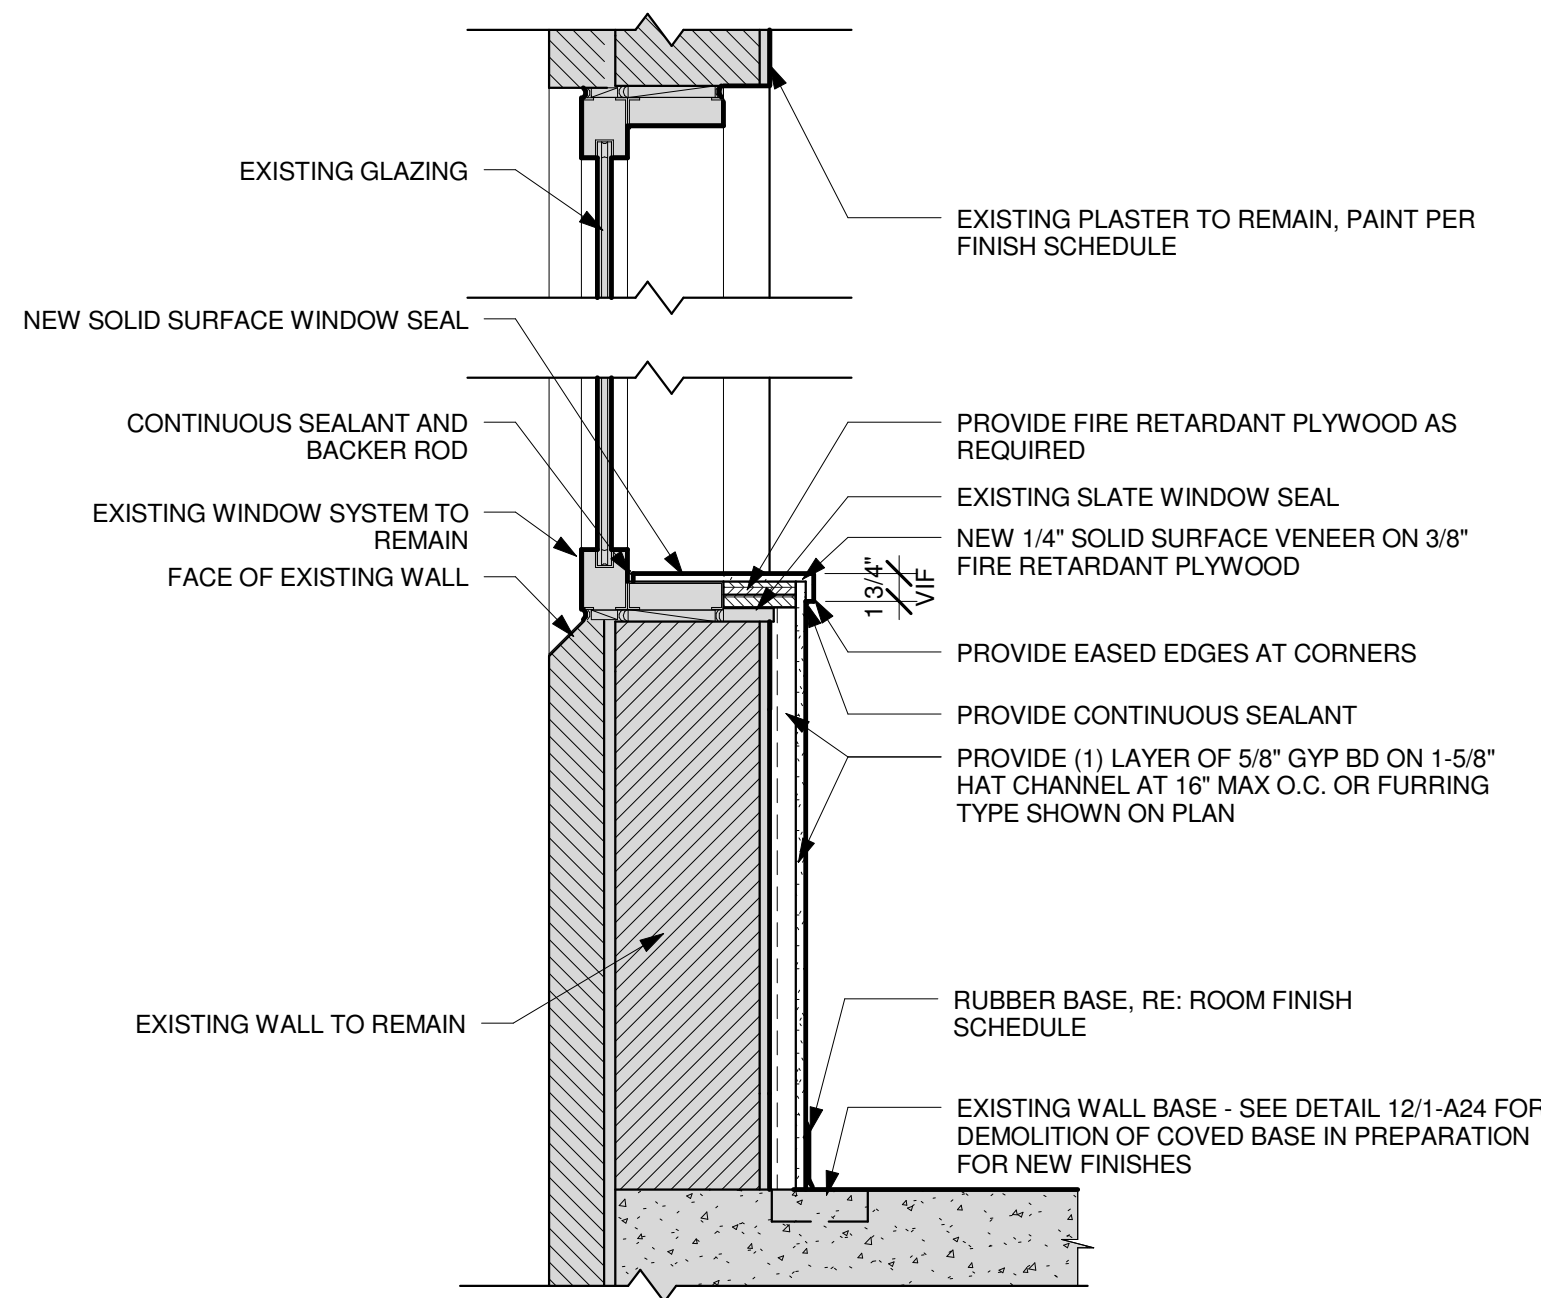
1 TYP. EXTERIOR WALL DETAIL - W/ CABINET
SCALE: 1" = 1'-0"



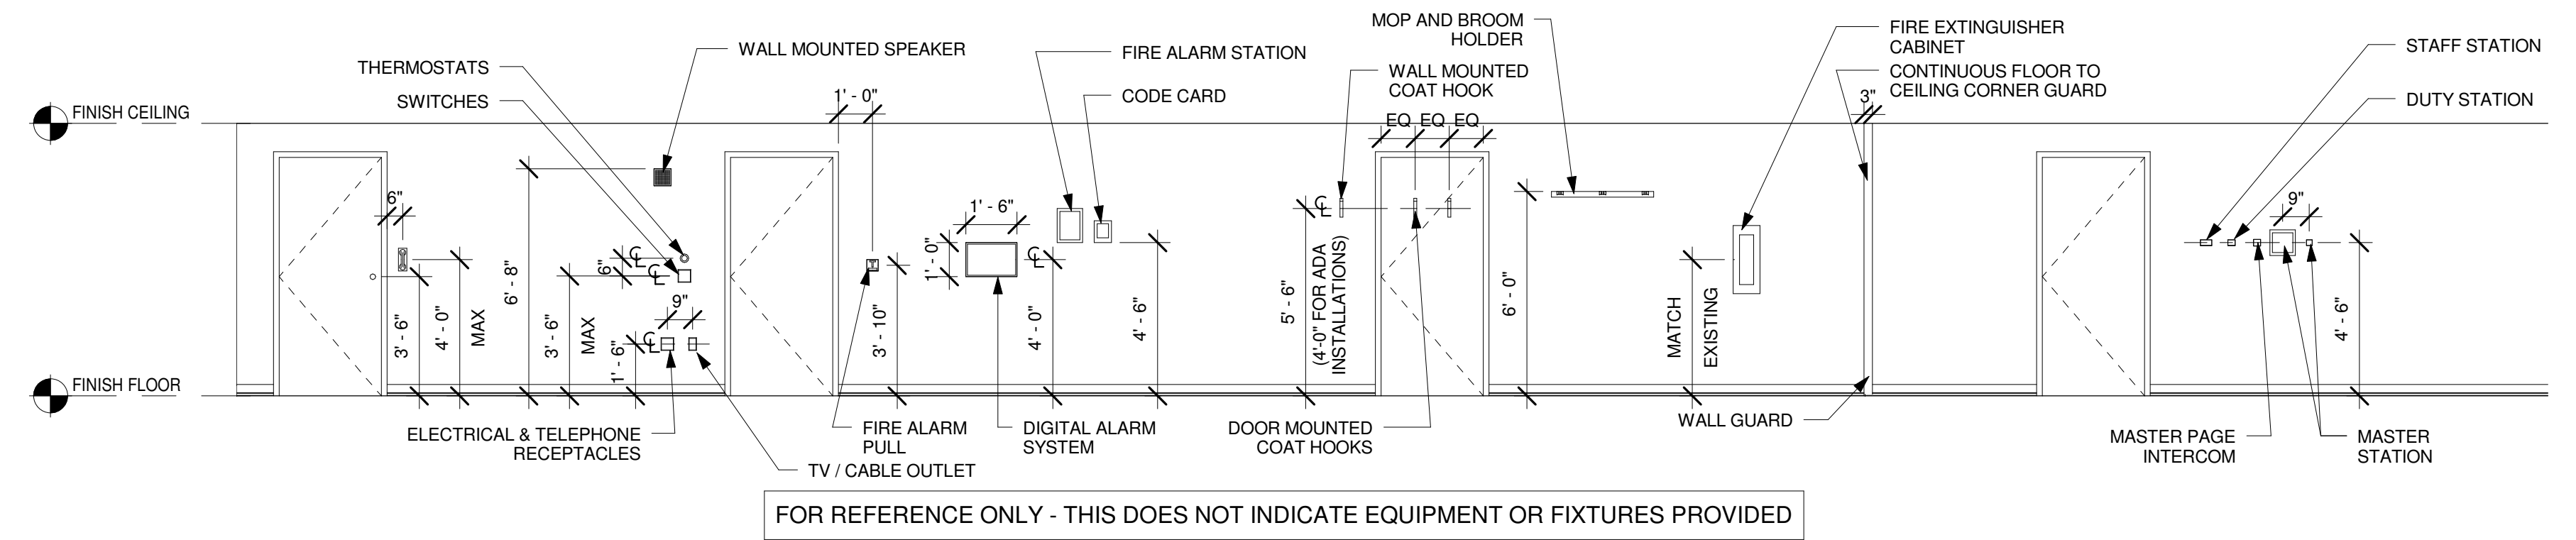
2 TYP. EXTERIOR WALL DETAIL - W/O CABINET
SCALE: 1" = 1'-0"
RE:1/1-AS301



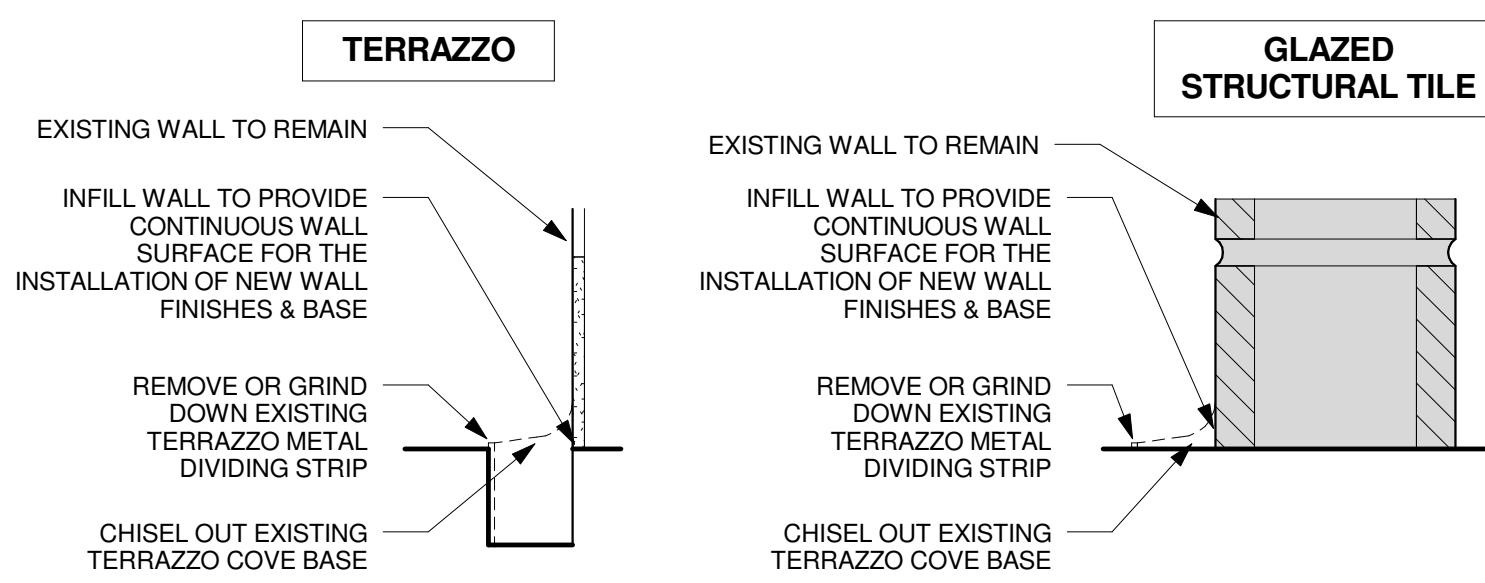
3 TYPICAL MOUNTING HEIGHTS - PUBLIC SPACES
SCALE: 1/4" = 1'-0"



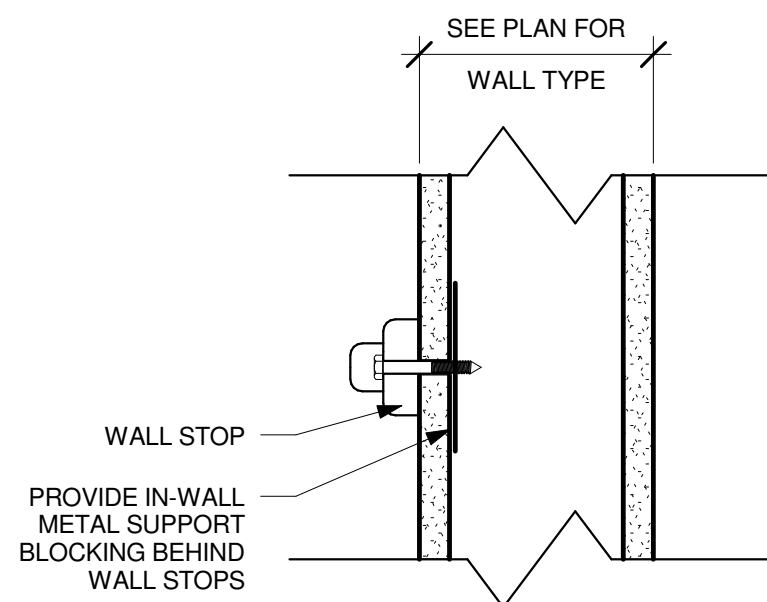
4 WALL BASE DEMOLITION DETAILS
SCALE: 3" = 1'-0"



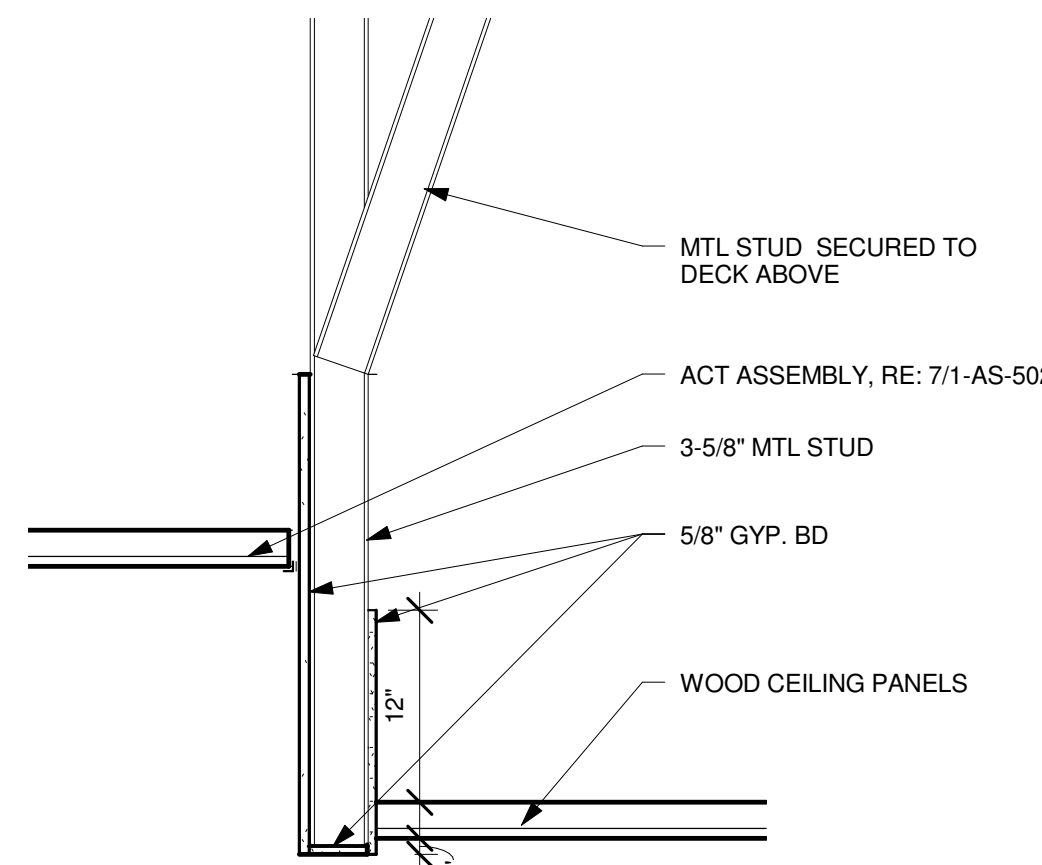
5 SUPPORT BLOCKING AT DOOR STOP
SCALE: 3" = 1'-0"



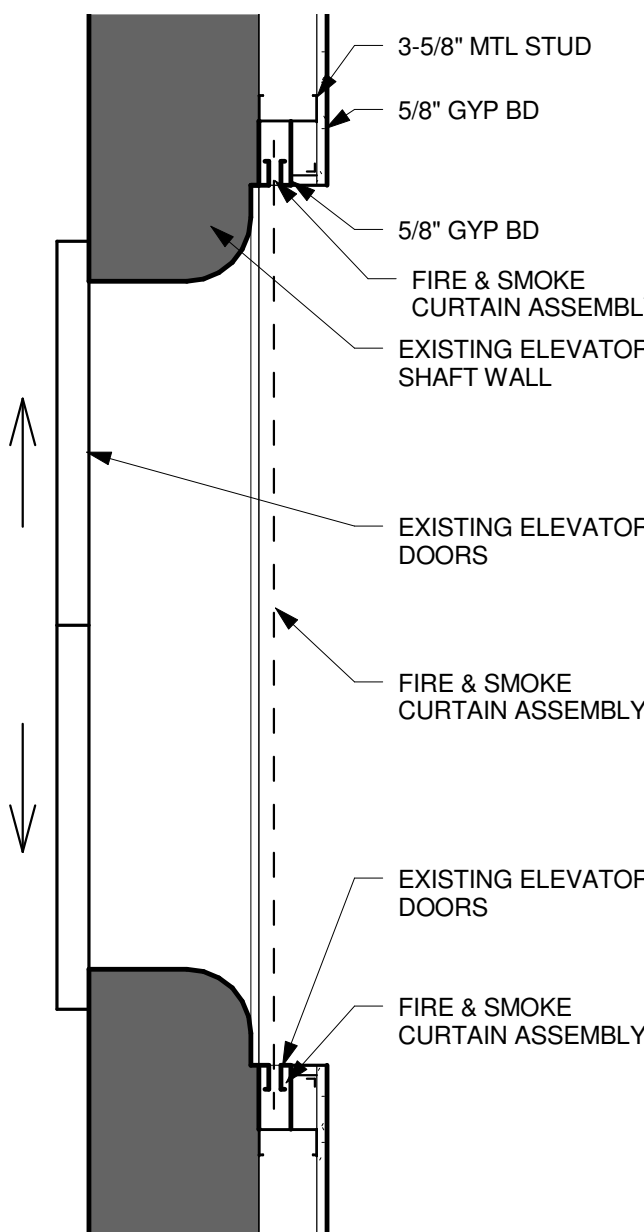
6 CURVED SOFFIT CEILING DETAIL
SCALE: 1" = 1'-0"
RE:1/1



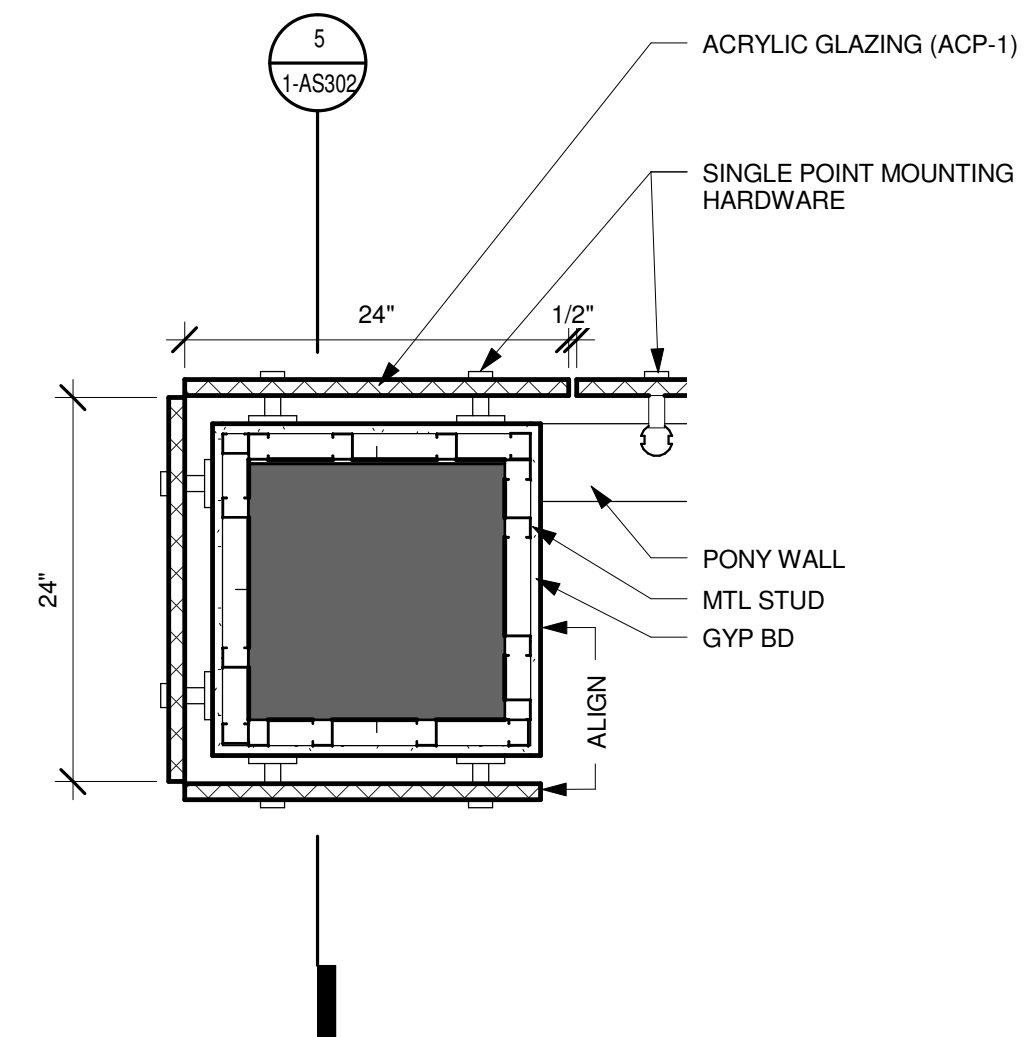7 TYPICAL PLAN DETAIL AT ELEVATOR JAMB
SCALE: 1" = 1'-0"
RE:3/1-AS302




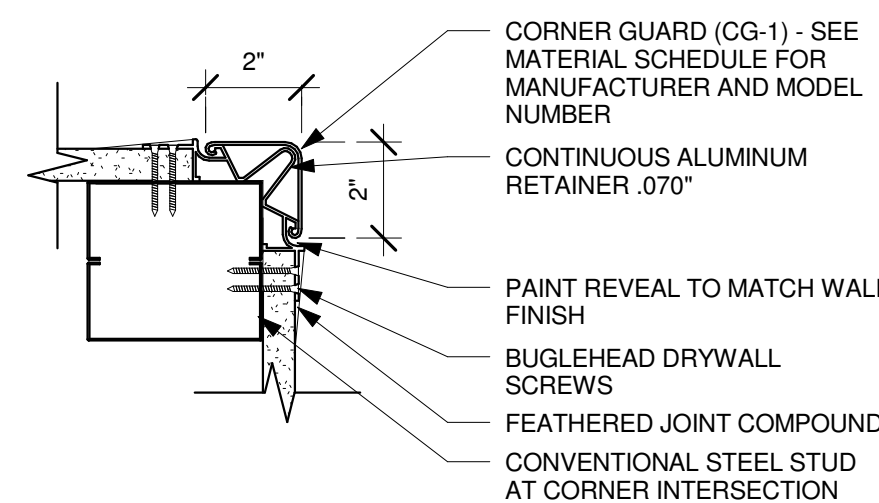8 PRIVACY WALL PLAN DETAIL AT COLUMN
SCALE: 1" = 1'-0"
RE:4/1-AS109



9 CORNERGUARD DETAIL
SCALE: 3" = 1'-0"

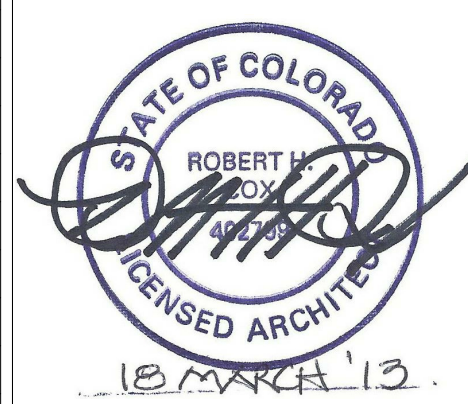BUILDING IS FULLY SPRINKLERED



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Tel: 763.315.7600
Fax: 763.315.7920



ARCHITECT/ENGINEERS:

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Approved: Chief, Police

Drawing Title
ARCHITECTURAL DETAILS

Location
**GRAND JUNCTION VAMC
2121 NORTH AVENUE
GRAND JUNCTION, CO 81501**

Project Name
RENOVATE 6TH FLOOR

Building Number
1

Checked
RHC

Drawn
CAW

Project Number
575-12-102

Date
12 APRIL 2013

Drawing Number
1-AS503

Dwg. of

Office of
Construction
and Facilities
Management



A
B
C
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F

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one and one half inches = one foot
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one half inch = one foot
one quarter inch = one foot
one eighth inch = one foot

ROOM FINISH SCHEDULE										
ROOM NUMBER	ROOM NAME	FLOOR	BASE	WALLS				CEILING	WINDOW TREATMENTS	ID FINISH REMARK
				NORTH	EAST	SOUTH	WEST			
6000	CONFERENCE ROOM / COMMAND CENTER	CPT-1/CPT-2	RB-1	PAE-1	PAE-1	PAE-1	PAE-1	ACT-1/ACT-5	SHD-1	TIDEX WAINSCOAT
6001	HOUSEKEEPING	VCT-1	RB-1/ TIDEX	PAE-1/TIDEX	PAE-1/TIDEX	PAE-1/TIDEX	PAE-1/TIDEX	ACT-1	NF	
6002	KITCHENETTE	HP-1/HP-2	RB-1	PAE-1	PAE-1	PAE-5	PAE-1	ACT-1	SHD-1	
6003	CORRIDOR	HP-1/HP-2	RB-1	PAE-1	PAE-1	PAE-1	PAE-1	ACT-1	NF	
6004	ADMINISTRATIVE OFFICER TO THE CHIEF OF STAFF	CPT-1	RB-1	PAE-6	PAE-1	PAE-1	PAE-1	ACT-1	SHD-1	
6005	CHIEF OF STAFF	CPT-1	RB-1	PAE-4	PAE-1	PAE-1	PAE-1	ACT-1	SHD-1	
6006	PATIENT SAFETY MANAGER	CPT-1	RB-1	PAE-5	PAE-1	PAE-1	PAE-1	ACT-1	SHD-1	
6007	ASSOCIATE DIRECTOR OF PATIENT CARE SERVICES	CPT-1	RB-1	PAE-6	PAE-1	PAE-1	PAE-1	ACT-1	SHD-1	
6008	DEPUTY ASSOCIATE DIRECTOR OF PATIENT CARE SERVICES	CPT-1	RB-1	PAE-1	PAE-1	PAE-1	PAE-1	ACT-1	SHD-1	
6009	ADMIN OFFICER TO THE ASSOCIATE DIRECTOR OF PATIENT CARE SERVICES	CPT-1	RB-1	PAE-1	PAE-1	PAE-1	PAE-1	ACT-1	SHD-1	
6010	COAT	HP-1	RB-1	PAE-1	PAE-1	PAE-1	PAE-1	ACT-1	NF	
6201	SECRETARIES	CPT-1	RB-1	PAE-1	PAE-1	PAE-1/ACP-1	PAE-1	ACT-2/ACT-3	NF	
6202	SECRETARIES	CPT-1	RB-1	PAE-1	PAE-6	PAE-1	PAE-1	ACT-1	NF	
6203	WAITING	HP-1/HP-2	RB-1	PAE-1/ACP-1	PAE-1	PAE-1	PAE-1	ACT-2/ACT-3	NF	
6204	ELEVATOR LOBBY	HP-3/HP-4	RB-1	PAE-1	PAE-1	PAE-3	PAE-3	ACT-1	NF	
6205	CORRIDOR	HP-3/HP-4	RB-1	PAE-1	PAE-3	PAE-1	PAE-1	ACT-1/ACT-2/ACT-3	NF	
6206	MEN'S RESTROOM	CTF-1/CTF-2	CTB-1	PT-1/CT-2/PAE-1	PT-1/PT-2/PAE-1	PT-1/PT-2/PAE-1	PT-1/PT-2/PAE-1	ACT-1	PRV-1	
6207	WOMEN'S RESTROOM	CTF-1/CTF-2	CTB-1	PT-1/CT-2/PAE-1	PT-1/PT-2/PAE-1	PT-1/PT-2/PAE-1	PT-1/PT-2/PAE-1	ACT-1	PRV-1	
6208	STORAGE	VCT-1	RB-1	PAE-1	PAE-1	PAE-1	PAE-1	ACT-1	NF	
6209	MECH / PLUMB	NF	RB-1	PAE-1	PAE-1	PAE-1	PAE-1	NF	NF	
6210	ELEC	NF	RB-1	PAE-1	PAE-1	PAE-1	PAE-1	NF	NF	
6211	STAIR	NIC	NIC	NIC	NIC	NIC	NIC	NIC	NIC	
6212	ELEVATOR	NIC	NIC	NIC	NIC	NIC	NIC	NIC	NIC	
6213	SERVICE ELEVATOR	NIC	NIC	NIC	NIC	NIC	NIC	NIC	NIC	
6214	PENTHOUSE STAIR	NIC	NIC	NIC	NIC	NIC	NIC	NIC	NIC	
6400	CORRIDOR	HPT-1/HP-2	RB-1	PAE-1	PAE-1	PAE-1	PAE-1	ACT-1	NF	
6401	SPECIAL ASSISTANT TO THE DIRECTOR	CPT-1	RB-1	PAE-1	PAE-1	PAE-4	PAE-1	ACT-1	SHD-1	
6402	WORKROOM	HP-1/HP-2	RB-1	PAE-1	PAE-1	PAE-1	PAE-1	ACT-2/ACT-3	SHD-1	
6403	ADMINISTRATIVE OFFICER TO THE ASSOCIATE DIRECTOR	CPT-1	RB-1	PAE-5	PAE-1	PAE-1	PAE-1	ACT-1	SHD-1	
6404	DIRECTOR'S SUITE AND CONFERENCE	CPT-1	RB-1	PAE-1	PAE-1	PAE-6	PAE-1	ACT-1	SHD-1	
6405	ASSOCIATE DIRECTOR	CPT-1	RB-1	PAE-1	PAE-1	PAE-1	PAE-1	ACT-1	SHD-1	
6406	CORRIDOR	HP-1/HP-2	RB-1	PAE-1	PAE-1	PAE-1	PAE-1	ACT-1	NF	
6407	STAIR	NIC	NIC	NIC	NIC	NIC	NIC	NIC	NIC	
6408	IT	NIC	NIC	NIC	NIC	NIC	NIC	NIC	NIC	
7001	PENTHOUSE	NIC	NIC	NIC	NIC	NIC	NIC	NIC	NIC	
7002	ELEVATOR ROOM	NIC	NIC	NIC	NIC	NIC	NIC	NIC	NIC	
7003	COMMUNICATION	NIC	NIC	NIC	NIC	NIC	NIC	NIC	NIC	

MATERIAL FINISH LEGEND

FLOOR FINISH LEGEND									
FINISH CODE	MATERIAL	MANUFACTURER	MANUFACTURER NO.	PATTERN	COLOR	EDGE	SIZE	SURFACE	ID FINISH REMARKS
HP-1	HETEROGENEOUS PVC	CENTIVA	CP 3302-C TK	TICK	FRUITWOOD	SQUARE	4" X 36"	---	---
HP-2	HETEROGENEOUS PVC	CENTIVA	CP 0321-C TK	TICK	HIGH FOREST	SQUARE	4" X 36"	---	---
HP-3	HETEROGENEOUS PVC	CENTIVA	NS 7110-E QU	---	PALE SANDSTONE	SQUARE	12" X 18"	---	---
HP-4	HETEROGENEOUS PVC	CENTIVA	NS 7112-E QU	---	CORDOVAN SANDSTONE	SQUARE	18" X 18"	---	---
VCT-1	VCT	JOHNSONITE	V-2626	---	SILVER DUST	---	12" X 12"	---	---
CPT-1	CARPET	MANNINGTON	WAYS II - CMCR	---	COMMERCE	---	---	---	---
CPT-2	CARPET	MANNINGTON	WAYS II - AMEN	---	AMENDMENT	---	---	---	---

BASE FINISH LEGEND								
FINISH CODE	MATERIAL	MANUFACTURER	MANUFACTURER NO.	PATTERN	COLOR	SIZE	BASE GROUT KEY	ID FINISH REMARKS
RB-1	RUBBER BASE	JOHNSONITE	45	---	SANDAL WOOD WB	4"	---	---

TILE FINISH LEGEND								
FINISH CODE	MATERIAL	MANUFACTURER	MANUFACTURER NO.	PATTERN	COLOR	SIZE	BASE GROUT KEY	ID FINISH REMARKS
PTB-1	TILE COVE BASE	AMERICAN OLEAN	S36C3T	ST. GERMAIN	SAUGE SE66	6" X 12"	GR-1	---
PT-1	WALL TILE	AMERICAN OLEAN	---	ST. GERMAIN	SAUGE SE66	6" X 24"	GR-1	---
PT-2	RESTROOM MOSAIC	AMERICAN OLEAN	---	ST. GERMAIN	CREME SE61	1" X 2"	GR-1	---
PT-3	TILE BULLNOSE	AMERICAN OLEAN	S43C9	ST. GERMAIN	SAUGE SE66	3" X 12"	GR-1	---
PT-4	FLOOR TILE	AMERICAN OLEAN	---	ST. GERMAIN	SAUGE SE66	12" X 12"	GR-1	---
PT-5	BACKSPLASH MOSAIC	AMERICAN OLEAN	---	ST. GERMAIN	SAUGE SE66	1" X 2"	GR-1	---
GR-1	TILE GROUT	LATICRETE	SANDED GROUT	---	BRIGHT WHITE	---	---	---
TET-1	TILE EDGE TRIM	RONDEC	SCHLUTER SYSTEMS	BRUSHED STAINLESS STEEL	---	--	GR-1	---

CEILING FINISH LEGEND									
FINISH CODE	MATERIAL	MANUFACTURER	MANUFACTURER NO.	PATTERN	COLOR	SIZE	EDGE	GRID	FINISH REMARKS
ACT-1	ACOUSTIC CEILING TILE	ARMSTRONG	S84	CRRUS REGULAR	---	24" X 24"	NF	WHITE 15/16" PRELUDE	---
ACT-2	WOOD PANEL CEILING TILE	ARMSTRONG	WOODWORKS 6464MI	UNPERFERATED TEGULAR	MAPLE	24" X 24"	NF , ACT-5	SILVER 15/16" PRELUDE	---
ACT-3	WOOD PANEL CEILING TILE	ARMSTRONG	WOODWORKS 6464MI	UNPERFERATED TEGULAR	MAPLE	3" X 48"	NF	SILVER 15/16" PRELUDE	---
ACT-4	WOOD PANEL CEILING TILE	ARMSTRONG	WOODWORKS 6464MI	UNPERFERATED TEGULAR	MAPLE	72" X 24"	NF , ACT-5	SILVER 15/16" PRELUDE	---
ACT-5	WOOD PANEL CEILING EDGE	ARMSTRONG	WOODWORKS 6464MI	---	MAPLE	4"	---	SILVER 15/16" PRELUDE	---

WALL FINISH LEGEND								
FINISH CODE	MATERIAL	MANUFACTURER	MANUFACTURER NO.	FINISH	COLOR	SIZE	GROUT	ID FINISH REMARKS
PA-1	PAINT	SHERWIN-WILLIAMS	SW 7566	EG SHELL	WESTHIGHLAND WHITE	---	---	---
PA-2	PAINT	SHERWIN-WILLIAMS	SW 7552	EG SHELL	BAUHAUS BUFF	---	---	---
PA-3	PAINT	SHERWIN-WILLIAMS	SW 7022	EG SHELL	ALPACA	---	---	---
PA-4	PAINT	SHERWIN-WILLIAMS	SW7733	EG SHELL	BAMBOO SHOOT	---	---	---
PA-5	PAINT	SHERWIN-WILLIAMS	SW2818	EG SHELL	RENWICK HEATHER	---	---	---
PA-6	PAINT	SHERWIN-WILLIAMS	SW 7664	EG SHELL	STEELY GRAY	---	---	---
PA-7	PAINT	SHERWIN-WILLIAMS	SW 7551	EG SHELL	GREEK VILLA	---	---	CEILING

WALL PROTECTION LEGEND								
FINISH CODE	MATERIAL	MANUFACTURER	STYLE	MANUFACTURER NO.	PATTERN	COLOR	SIZE	ID FINISH REMARKS
CG-1	CORNER GUARD	INPRO	160 FR-1	239	---	OATMEAL	---	---
HR-1	HANDRAIL	INPRO	800	239	---	OATMEAL	---	---
EW-1	ENDWALL	INPRO	140D	239	---	OATMEAL	---	---

MISCELLANEOUS FINISH LEGEND						
FINISH CODE	MATERIAL	MANUFACTURER NO.	MANUFACTURER	PATTERN	COLOR	FINISH REMARKS
ACP-1	ACRYLIC GLAZING	---	3FORM	BIRCH GROVE	SANDSTONE (BACKING)	48" X 48" X 1/2"
DR-1	DOOR FINISH	1150-58	FORMICA	MATTE	VOSGES PEAR	DOORS
PRV-1	GLAZING	---	---	PRIVACY GLAZING	---	---
PLAM-1	PLASTIC LAMINATE	1150-58	FORMICA	MATTE	VOSGES PEAR	---
PLAM-2	PLASTIC LAMINATE	---	---	---	---	---
SS-1	SOLID SURFACE	CLASSIC CL102	HANSTONE	---	CHAMPAGNE PEARL	3/4"
---	---	---	---	---	---	---
---	---	---	---	---	---	---
---	---	---	---	---	---	---

OWNER PROVIDED ITEMS

INSTALLED ITEM	OWNER FURNISHED CONTRACTOR INSTALLED	OWNER FURNISHED OWNER INSTALLED	CONTRACTOR FURNISHED CONTRACTOR INSTALLED	COMMENT
SOAP DISPENSER		X		
HAND SANITIZER DISPENSER		X		
LOTION DISPENSER		X		
WALL MOUNTED TV		X		
MARKERBOARD		X		

GENERAL FINISH NOTES

- REFER TO THE REFLECTED CEILING PLANS FOR COMBINATION CEILING (SUSPENDE ACOUSTICAL CEILINGS SYSTES AND SUSPENDE GYPSUM BOARD OR OTHER COMBINATIONS) AND CEILING HEIGHTS.
- WHERE VCT MEETS RESILIENT SHEET FLOORING, PROVIDE RESILIENT EDGE STRIP IN COLOR TO MATCH SHEET FLOORING. ALIGN STRIP UNDER CENTER OF DOOR.
- ACCENT WALLS ARE LOCATED ON THE FINISH FLOOR PLAN AND INTERIOR ELEVATIONS AND NOTED ON THE FINISH SCHEDULE.
- ALL GYPSUM BOARD CEILINGS SHALL RECIEVE FINISH.
- ALL GYPSUM BOARD CEILINGS AND SOFFITS SHALL RECEIVE FINISH.
- PAINT COLORS REFER TO SHEET 1-AS601.
- MANUFACTURER'S TRADE NAMES AND NUMBERS USED HEREIN ARE ONLY TO IDENTIFY COLORS, FINISHES, TEXTURES AND PATTERNS. PRODUCTS OF OTHER MANUFACTURER'S EQUIVALENT TO COLORS, FINISHES, TEXTURES AND PATTERNS OF MANUFACTURERS LISTED THAT MEET REQUIREMENTS OF TECHNICAL SPECIFICATIONS WILL BE ACCEPTABLE, UPON APPROVAL IN WRITING, BY THE COR FOR FINISH REQUIREMENTS.
- FOR THE FINISH LOCATION INFORMATION REFER TO THE FINISH SCHEDULE DRAWINGS.
- FOR CASEWORK AND MILLWORK SCHEDULES AND KEY TO FINISHES REFER TO THE FINISH SCHEDULE DRAWINGS
- ALL WINDOW SILLS TO BE SOLID SURFACE, REFER TO THE FINISH SCHEDULE DRAWINGS.

BUILDING IS FULLY SPRINKLERED

Revisions:

Date:

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Approved: Medical Center Director

Approved: Associate Director

Approved: Chief, Facility Mgmt

Approved: Safety Officer

Approved: Chief, IT

Approved: Service Chief

Approved: Chief, EMS

Approved: Chief, Infection Control

Approved: Chief, Police

Drawing Title

ROOM FINISH SCHEDULE

Location

GRAND JUNCTION VAMC
2121 NORTH AVENUE
GRAND JUNCTION, CO 81501

Project Name

RENOVATE 6TH FLOOR

Building Number

1

Checked

RHC

Drawn

PJ

Project Number

575-12-102

Date

12 APRIL 2013

Drawing Number

1-AS601


Dwg. of

Office of Construction and Facilities Management


Department of Veterans Affairs

A
three inches = one foot
B
one and one half inches = one foot
C
one inch = one foot
D
three quarters inch = one foot
E
one half inch = one foot
F
three eighths inch = one foot
one quarter inch = one foot
one eighth inch = one foot


DOOR SCHEDULE													
ROOM #	ROOM NAME	DOOR NUMBER	DOOR		MATERIAL	FINISH	TYPE	FRAME			HARDWARE GROUP	NOTES	
			Width	HEIGHT				MATERIAL	FINISH	TYPE			
6000	CONFERENCE ROOM / COMMAND CENTER	6000A	3' - 0"	7' - 0"	WD		1	HM	PAE-3	A	1		
6000	CONFERENCE ROOM / COMMAND CENTER	6000B	3' - 0"	7' - 0"	WD		1	HM	PAE-3	A	1		
6000	CONFERENCE ROOM / COMMAND CENTER	6000C	3' - 0"	7' - 0"	WD		1	HM	PAE-3	A	1		
6002	KITCHENETTE	6002	3' - 0"	7' - 0"	WD		1	HM	PAE-3	A	3		
6003A	HOUSEKEEPING	6003A	3' - 0"	7' - 0"	WD		1	HM	PAE-3	A	6		
6003B	COAT	6003B	3' - 0"	7' - 0"	WD		1	HM	PAE-3	A	3		
6004	ADMINISTRATIVE OFFICER TO THE CHIEF OF STAFF	6004	3' - 0"	7' - 0"	WD		1	HM	PAE-3	A	1		
6005	CHEIF OF STAFF	6005	3' - 0"	7' - 0"	WD		1	HM	PAE-3	A	1		
6006	PATIENT SAFETY MANAGER	6006	3' - 0"	7' - 0"	WD		1	HM	PAE-3	A	1		
6007	ASSOCIATE DIRECTOR OF PATIENT CARE SERVICES	6007	3' - 0"	7' - 0"	WD		1	HM	PAE-3	A	1		
6008	DEPUTY ASSOCIATE DIRECTOR OF PATIENT CARE SERVICES	6008	3' - 0"	7' - 0"	WD		1	HM	PAE-3	A	1		
6009	ADMIN OFFICER TO THE ASSOCIATE DIRECTOR OF PATIENT CARE SERVICES	6009	3' - 0"	7' - 0"	WD		1	HM	PAE-3	A	1		
6204	PENTHOUSE DOOR	6204	3' - 0"	7' - 0"	MTL	PAE- 3	1	HM	PAE-3	A	6		
6210	ELEC	6205	3' - 6"	7' - 0"	EXISTING			EXISTING	PAE-3	A	EXISTING	EXISTING	
6206	MEN'S RESTROOM	6206	3' - 0"	7' - 0"	WD		1	HM	PAE-3	A	2	POWER ASSIST	
6207	WOMEN'S RESTROOM	6207	3' - 0"	7' - 0"	WD		1	HM	PAE-3	A	2	POWER ASSIST	
6208	STORAGE	6208	3' - 0"	7' - 0"	WD		1	HM	PAE-3	A	3		
6210	ELEC	6210	3' - 0"	7' - 0"	WD		1	HM	PAE-3	A	6		
6400	CORRIDOR	6400	7' - 0"	7' - 0"	WD		1	HM	PAE-3	B	5	PAIR, ASTRAGAL	
6404	DIRECTOR'S SUITE AND CONFERENCE	6404A	3' - 0"	7' - 0"	WD		1	HM	PAE-3	A	1		
6404	DIRECTOR'S SUITE AND CONFERENCE	6404B	3' - 0"	7' - 0"	WD		1	HM	PAE-3	A	1		
6405	ASSOCIATE DIRECTOR	6405	3' - 0"	7' - 0"	WD		1	HM	PAE-3	A	1		
6406	CORRIDOR	6406A	3' - 6"	7' - 0"	EXISTING	-	-	EXISTING	EXISTING / PAE-3	A	EXISTING	EXISTING	

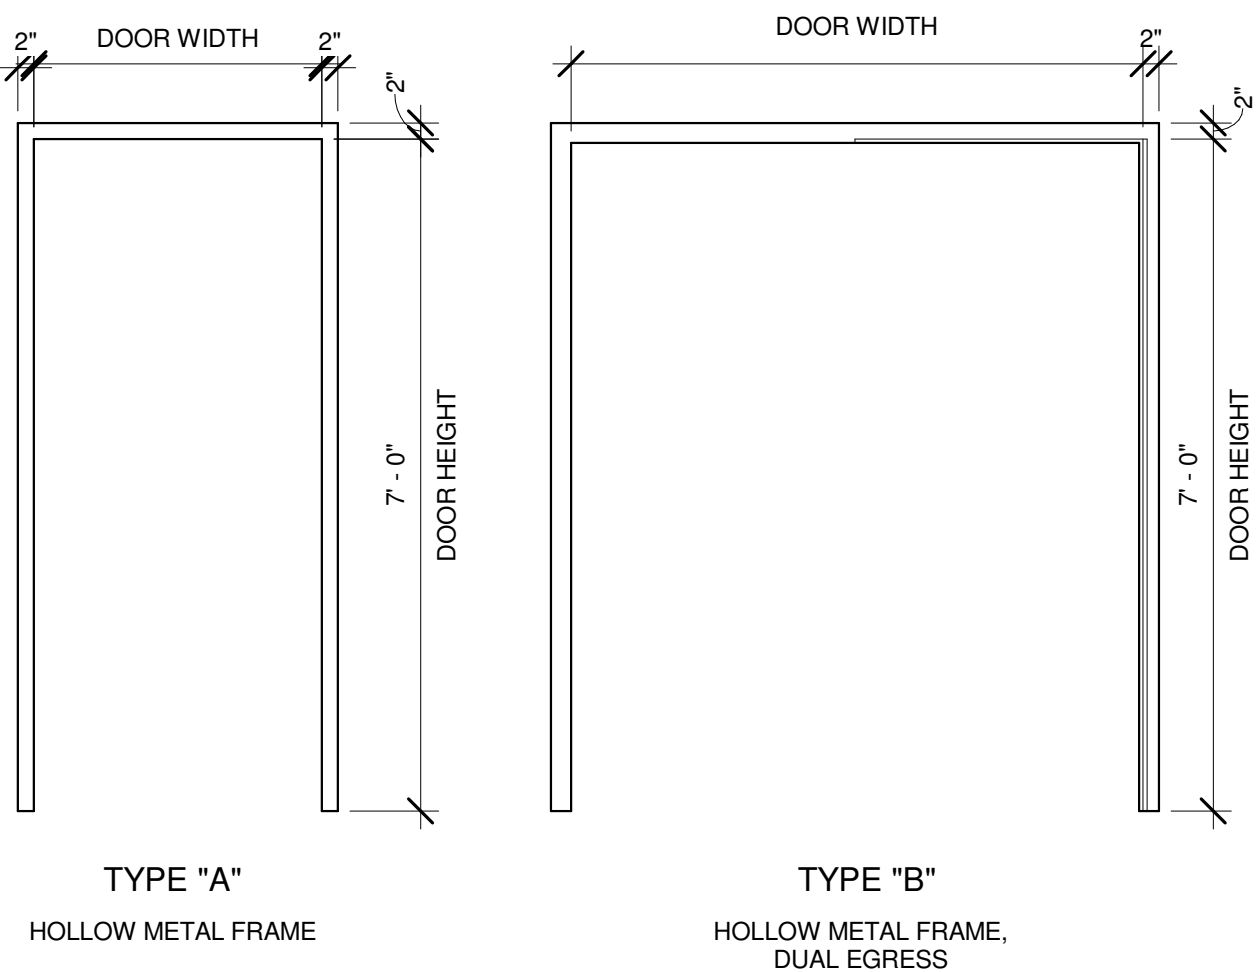

FRAME TYPES
NTS

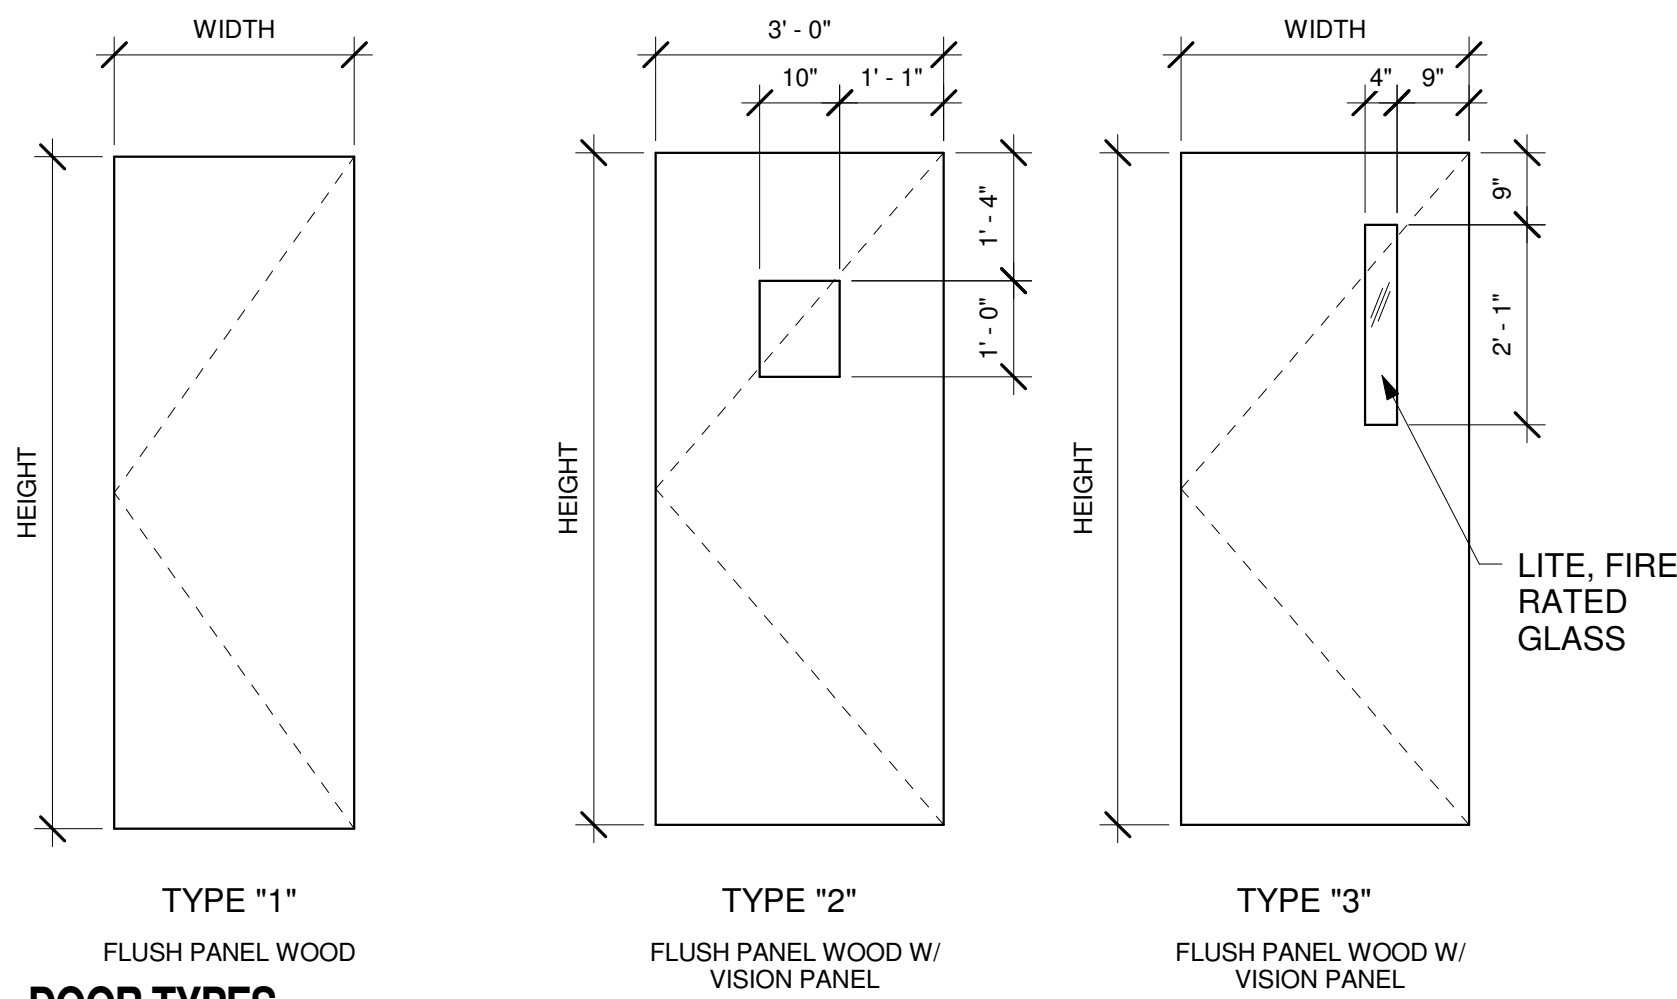

DOOR TYPES
NTS

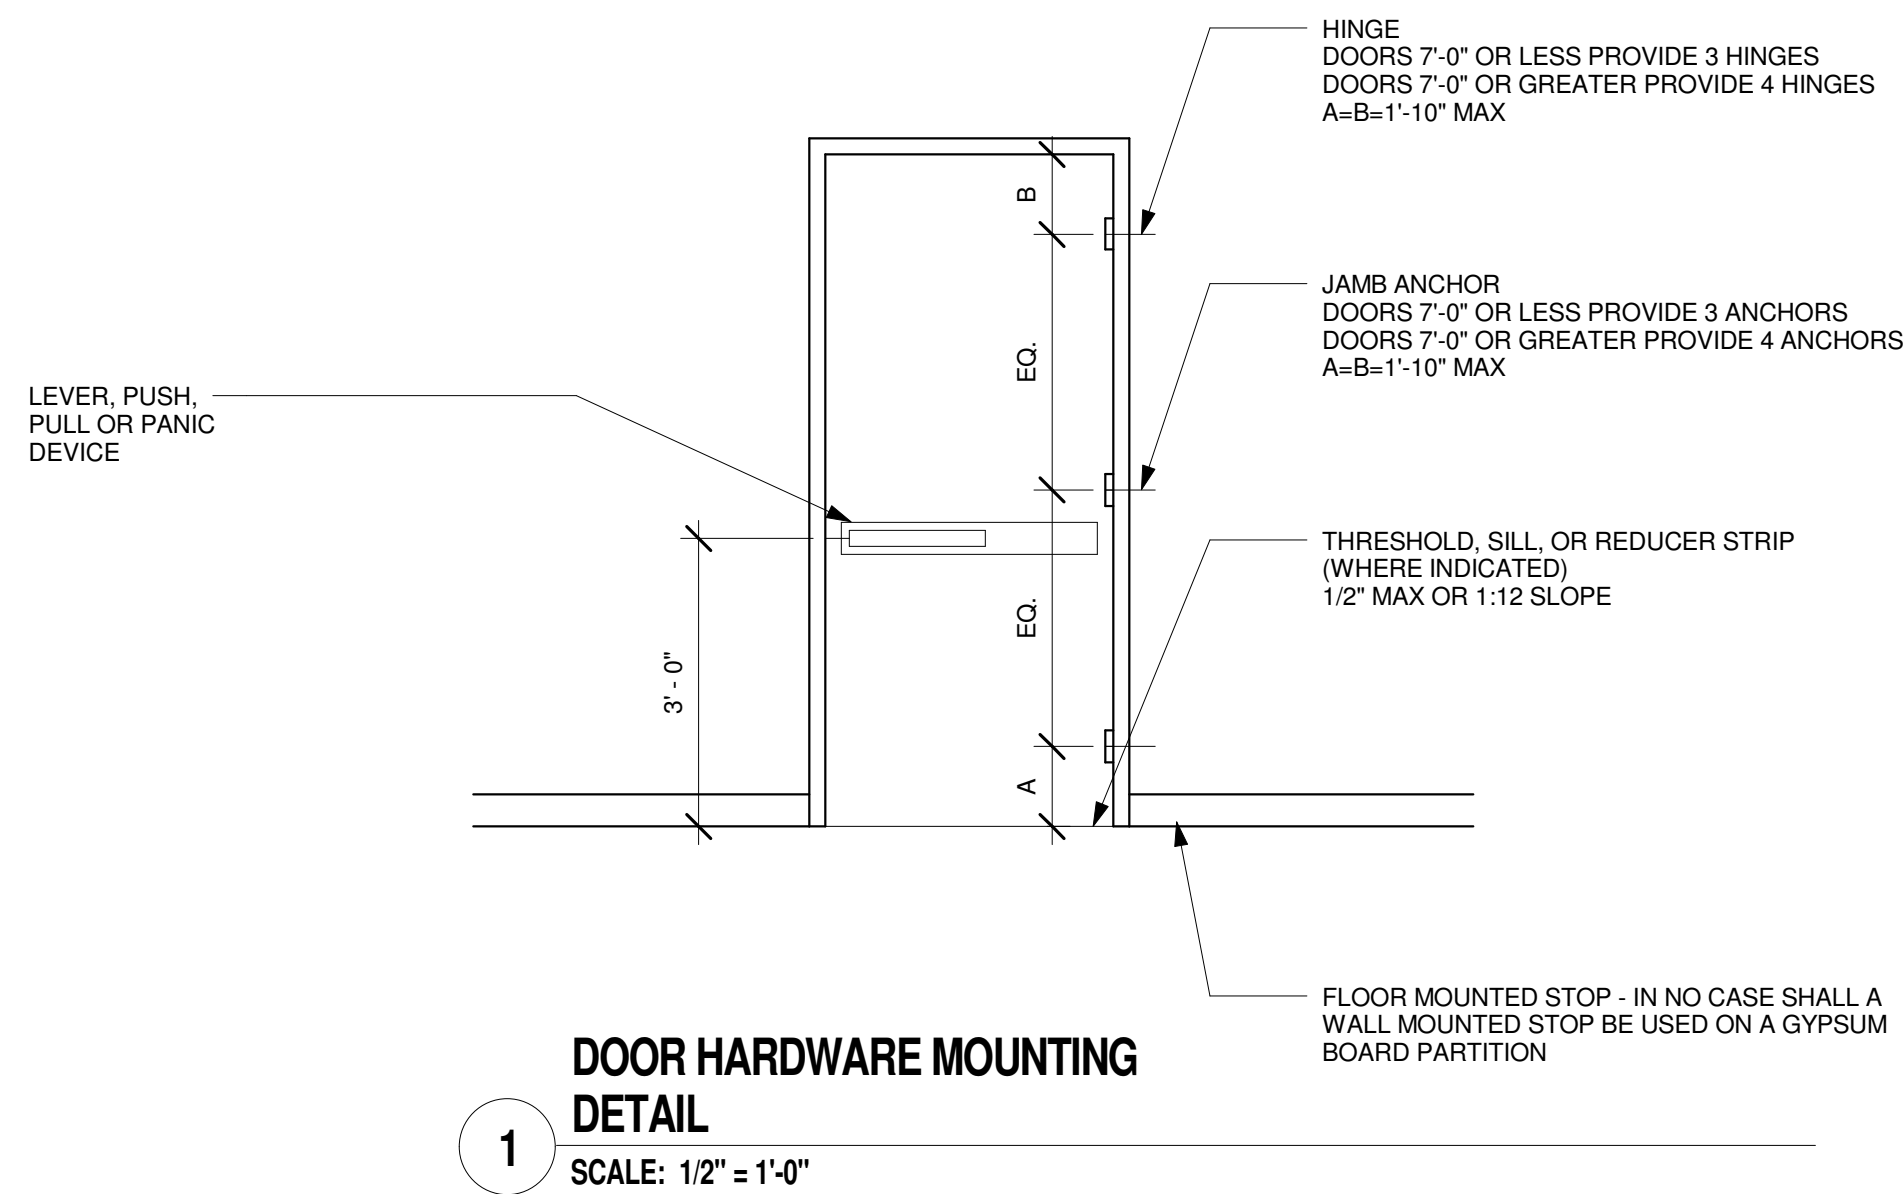

DOOR HARDWARE MOUNTING
DETAIL
1
SCALE: 1/2" = 1'-0"

GENERAL FINISH NOTES

- CONTRACTOR IS RESPONSIBLE FOR COORDINATING DOORS, DOOR FRAMES, AND HARDWARE.
- HARDWARE SUPPLIER IS RESPONSIBLE FOR BUILDING CODE AND FIRE RATED DOOR REQUIREMENTS.
- ALL FIRE RATED DOORS SHALL HAVE APPLIED U.L. LABEL ON HINGE SIDE. CONTRACTOR SHALL NOT REMOVE OR PAINT OVER LABEL.
- DOOR FRAMES SIZES TO BE VERIFIED WITH WALL THICKNESS ON THE JOB SITE BY CONTRACTOR.
- PROVIDE (2) 16 GAUGE METAL STUDS AT ALL DOOR JAMBS AND PARTITION CORNERS.
- ALL TEMPERED GLASS SHALL BE PERMANENTLY STAMPED TO INDICATE THAT IT IS TEMPERED.
- ALL DOORS REQUIRE BEVELED EDGES AT ALL 90 DEGREE INTERSECTIONS BEVEL 1-8" MIN, RADIUS, TYP.
- AFTER INSTALLATION OF EACH DOOR FRAME, (EXCLUDING ALUMINUM), MARK ON THE INTERIOR AND EXTERIOR OF THE FRAME THE ROOM NUMBER WITH INK WHICH WILL NOT BE VISIBLE AFTER THE SPECIFIED FINISH IS COMPLETE.
- DOOR INDICATED AS NRST ON THE DOOR SCHEDULE ARE NON RATED SMOKE TIGHT DOORS

DOOR ABBREVIATIONS

Pr	PAIR
UPr	UNEVEN PAIR
HM	HOLLOW METAL
HW	HARDWARE
MIN	MINUTES
MANUF	MANUFACTURER
NRST	NON-RATED, SMOKE TIGHT
SCWD	SOLID CORE WOOD DOOR
EX	EXISTING
(SEE SPECIFICATIONS FOR ADDITIONAL ABBREVIATES)	

**BUILDING IS
FULLY
SPRINKLERED**

Revisions:	Date	12 APRIL 2013	CONSULTANTS:	ARCHITECT/ENGINEERS:	Approved: Medical Center Director	Approved: Safety Officer	Approved: Chief, EMS	Drawing Title	Project Name	Project Number	Office of Construction and Facilities Management
					Approved: Associate Director	Approved: Chief, IT	Approved: Chief, Infection Control	DOOR SCHEDULE/ FRAME & DOOR ELEVATIONS	RENOVATE 6TH FLOOR	575-12-102	Department of Veterans Affairs
					Approved: Chief, Facility Mgmt	Approved: Service Chief	Approved: Chief, Police	Location		Date	
								GRAND JUNCTION VAMC		12 APRIL 2013	
								2121 NORTH AVENUE		Drawing Number	
								GRAND JUNCTION, CO 81501		1-AS602	
									Building Number	Checked	Drawn
									1	RHC	PJ
										Dwg. of	

A

three inches = one foot

B

one and one half inches = one foot

C

one inch = one foot

D

three quarters inch = one foot

E

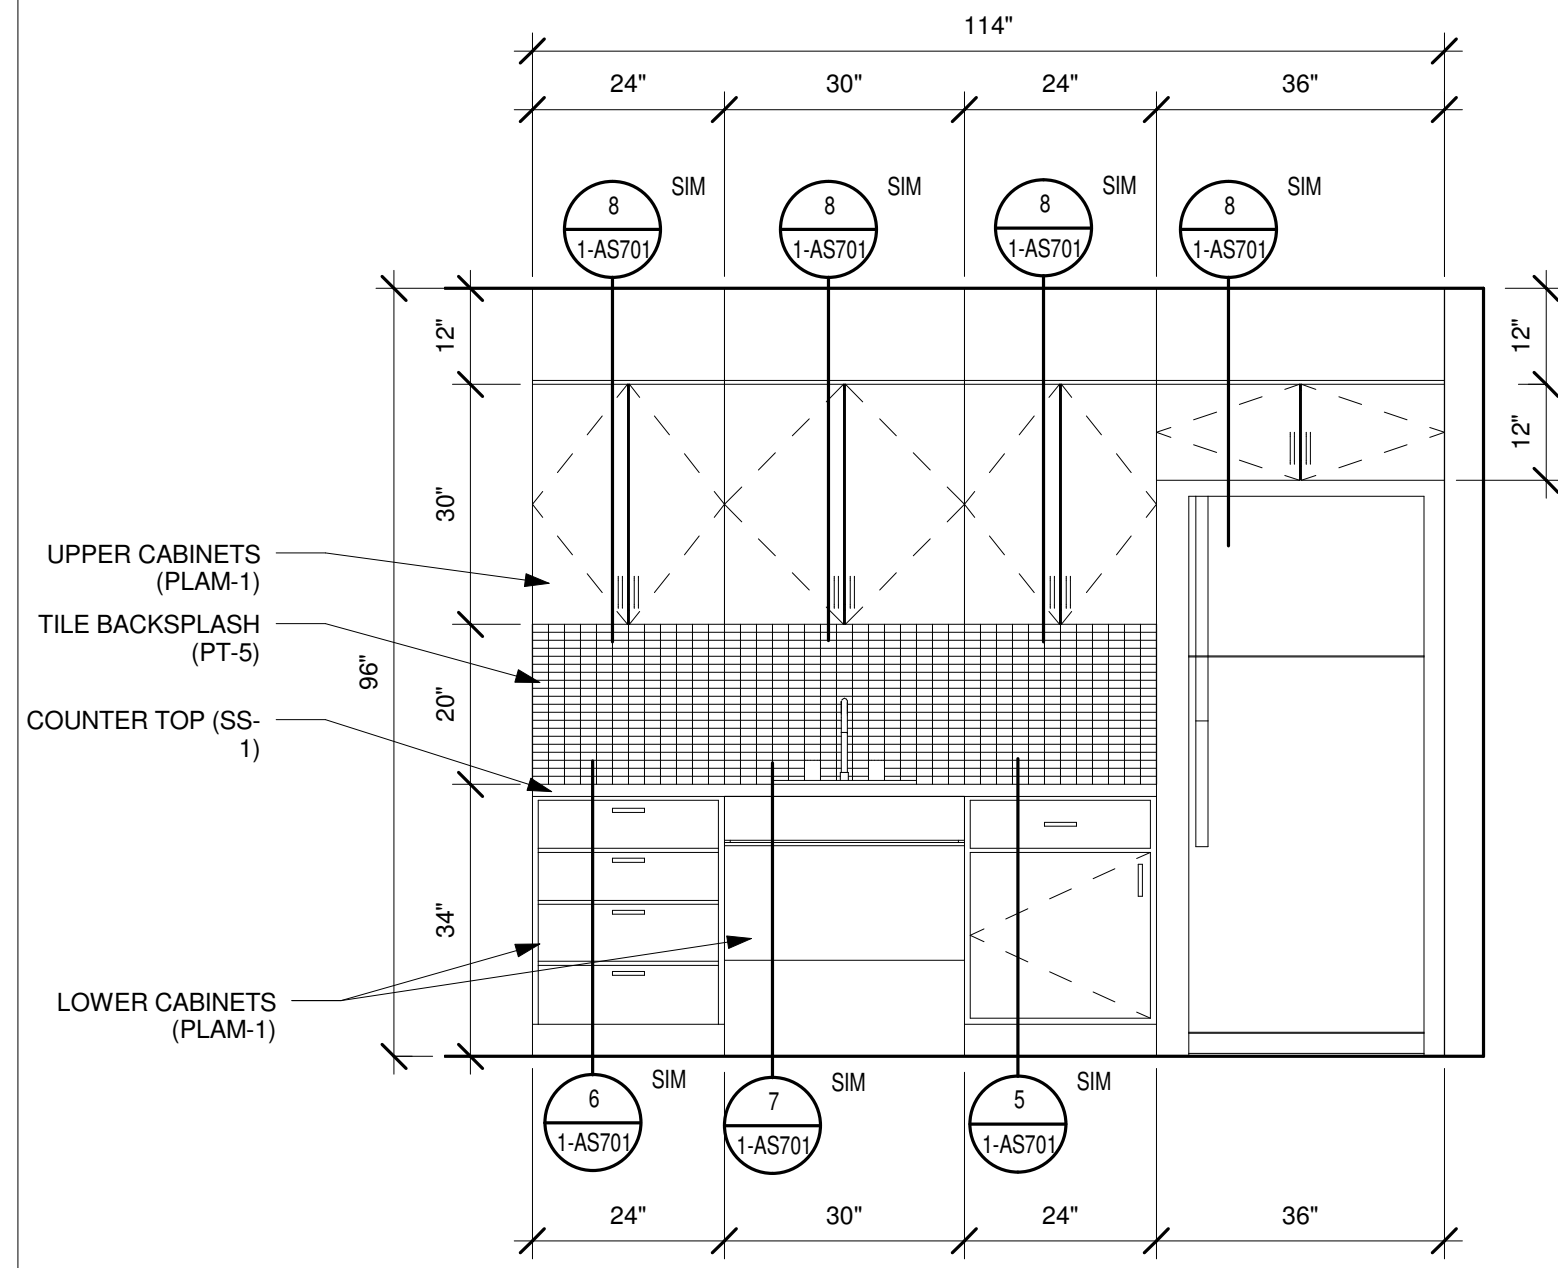
one half inch = one foot

F


three eighths inch = one foot

one quarter inch = one foot


one eighth inch = one foot



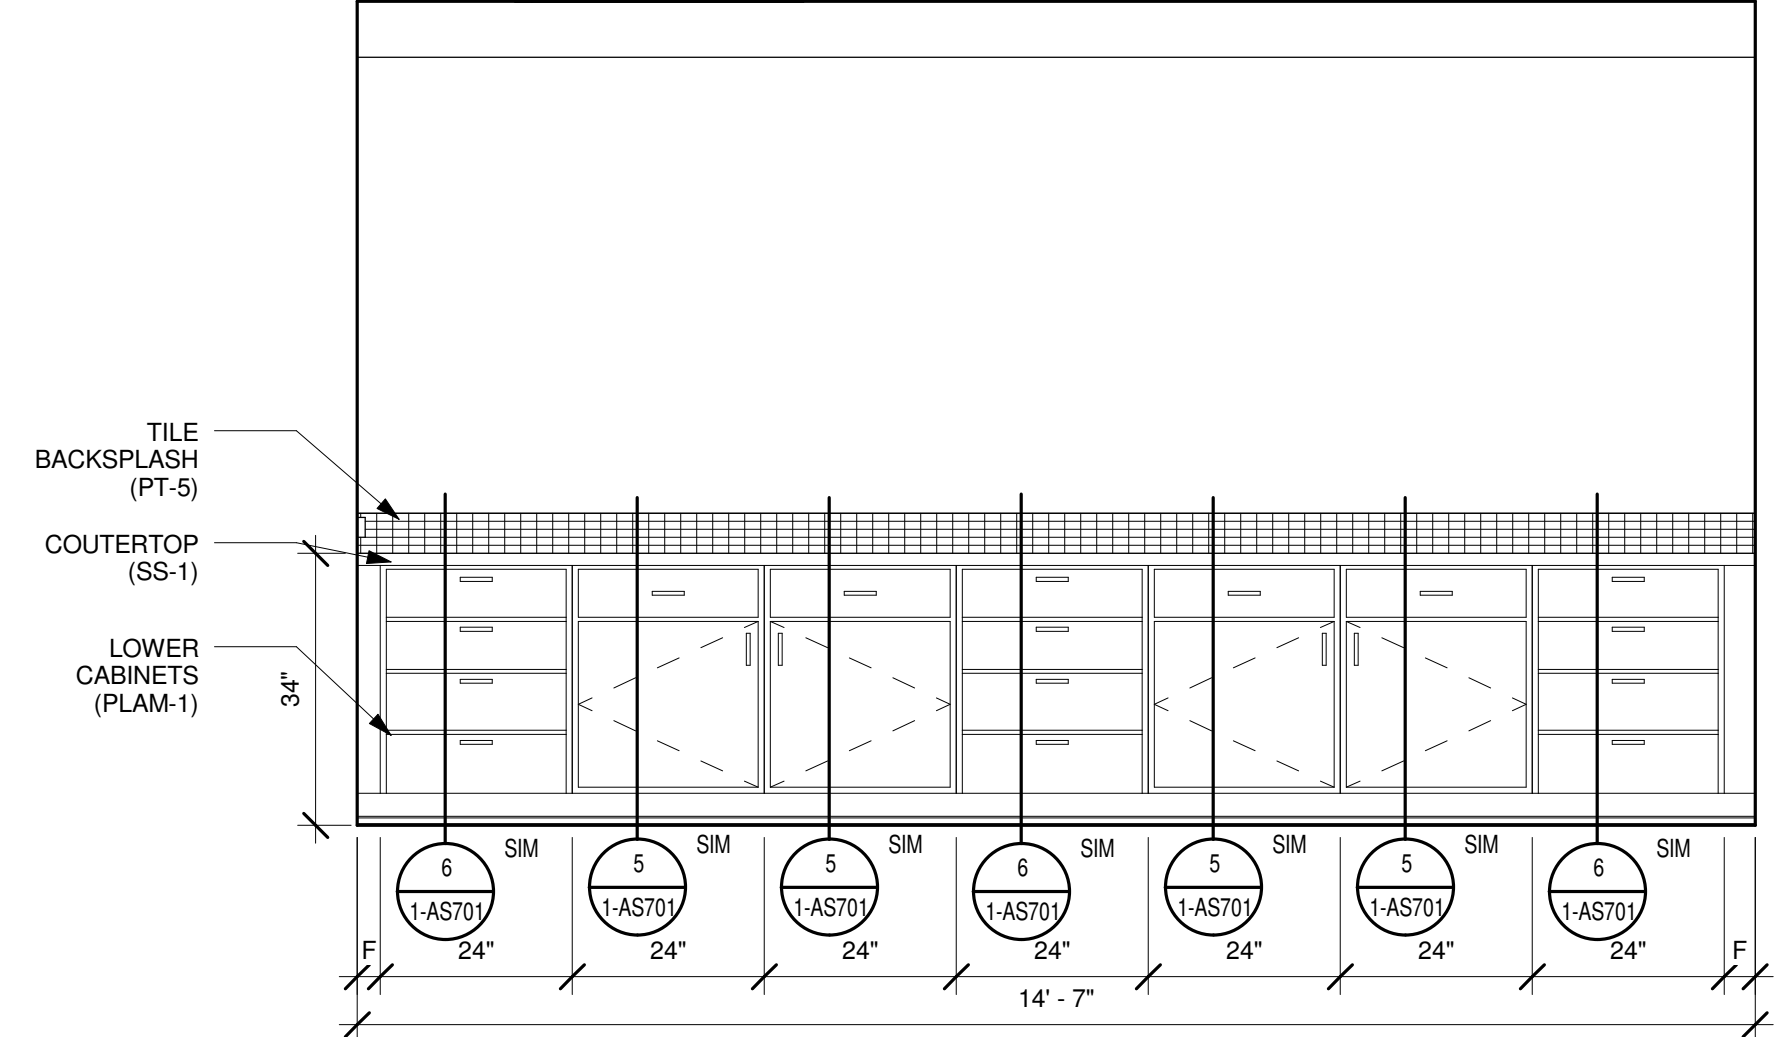
1 MILLWORK @ KITCHENETTE - 6002 - EAST
SCALE: 1/2\" = 1'-0\"
RE:10 /1-AS201



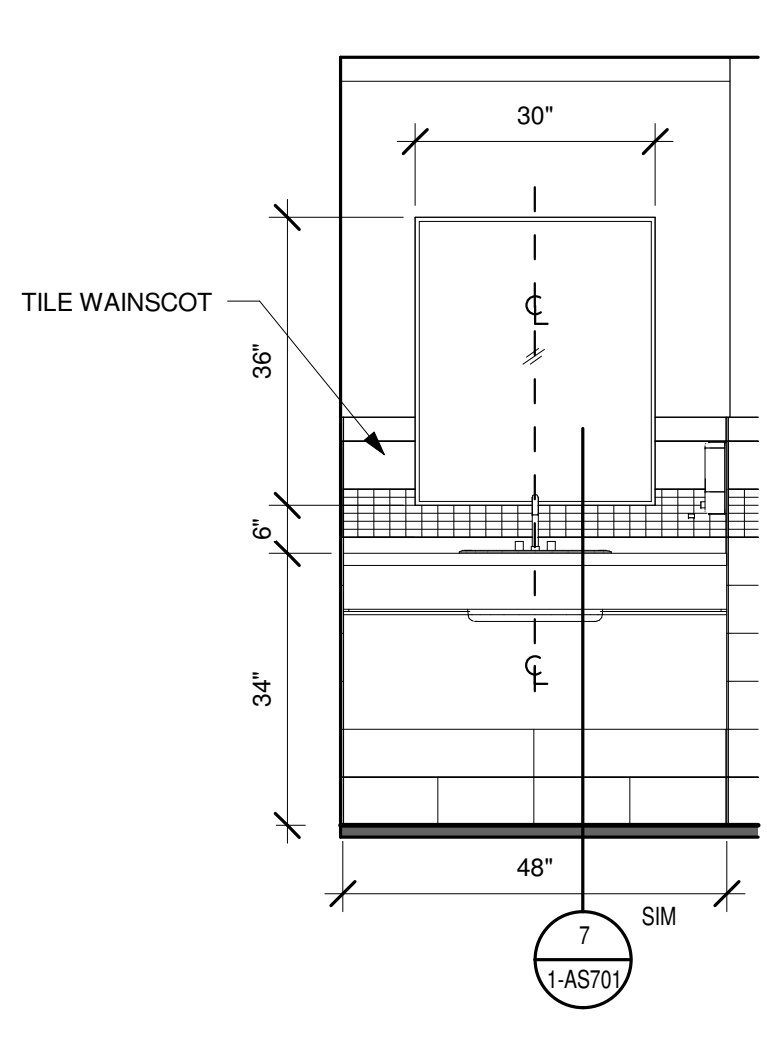
2 MILLWORK @ WORKROOM - 6402 - WEST
SCALE: 1/2\" = 1'-0\"
RE:17 /1-AS201



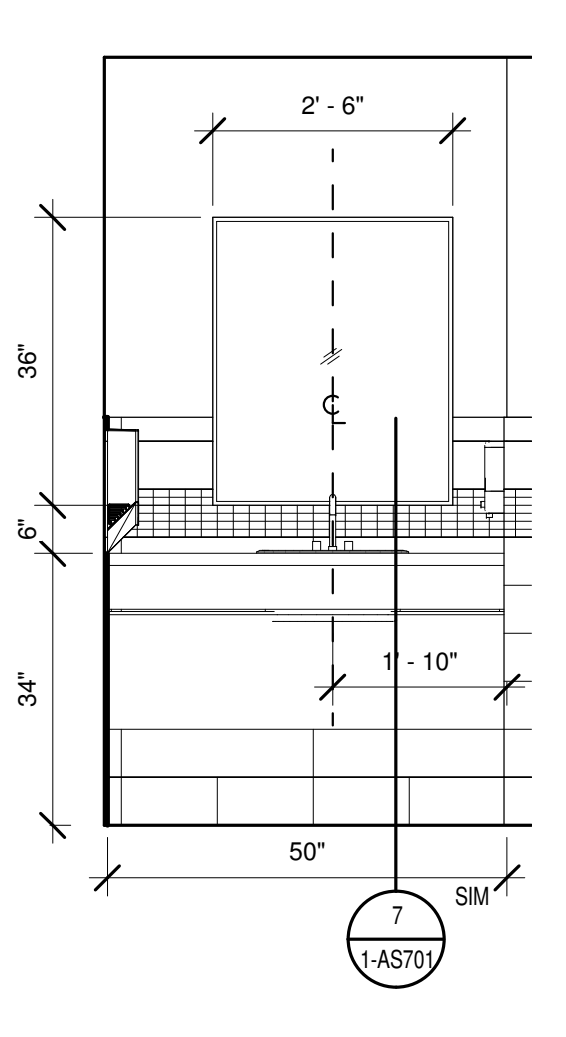
3 MILLWORK @ MEN'S RESTROOM - 6206 - NORTH
SCALE: 1/2\" = 1'-0\"
RE:7 /1-AS201



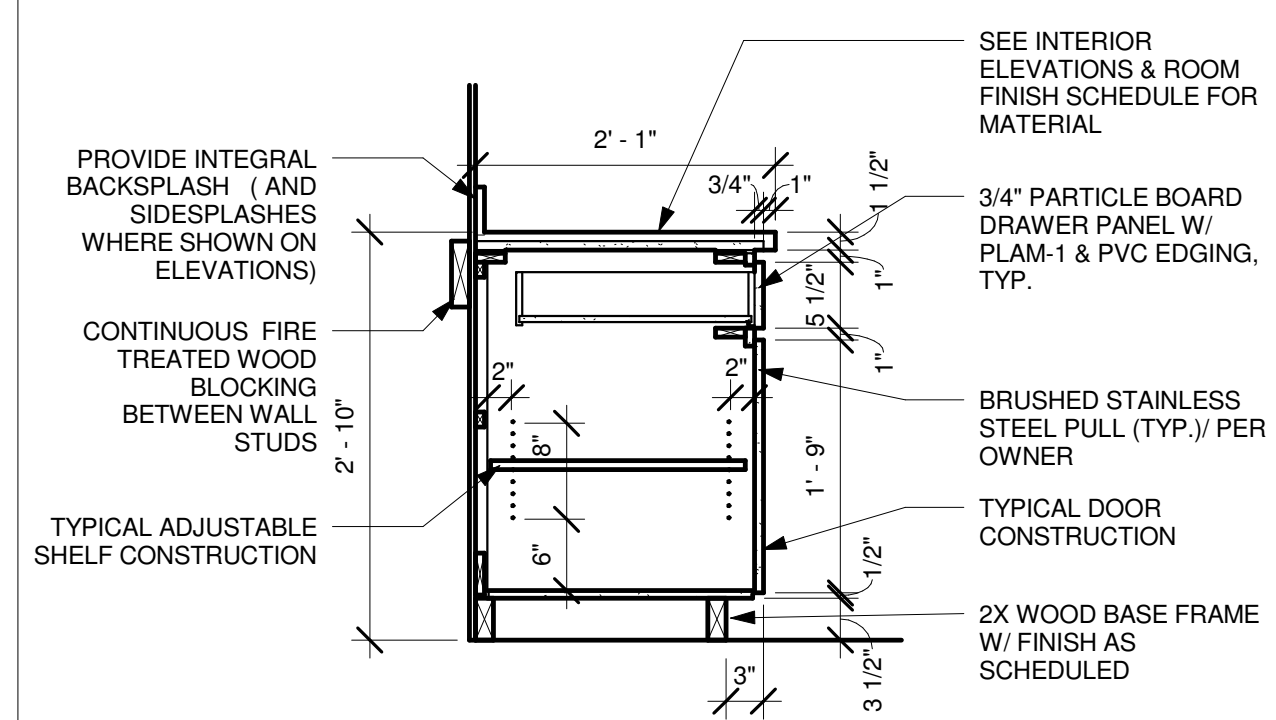
4 MILLWORK @ WOMEN'S RESTROOM - 6207 - NORTH
SCALE: 1/2\" = 1'-0\"
RE:3 /1-AS201



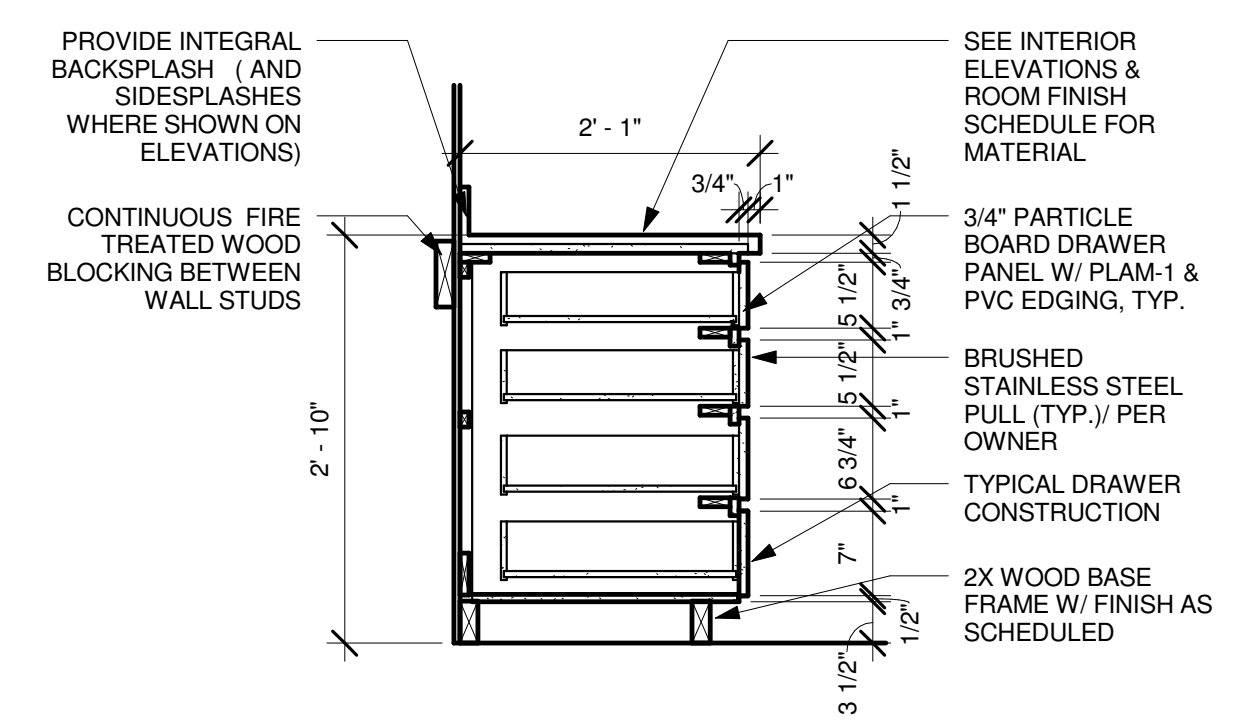
5 BASE CABINET W/ DRAWER & DOORS
SCALE: 3/4\" = 1'-0\"
RE:1 /1-AS701



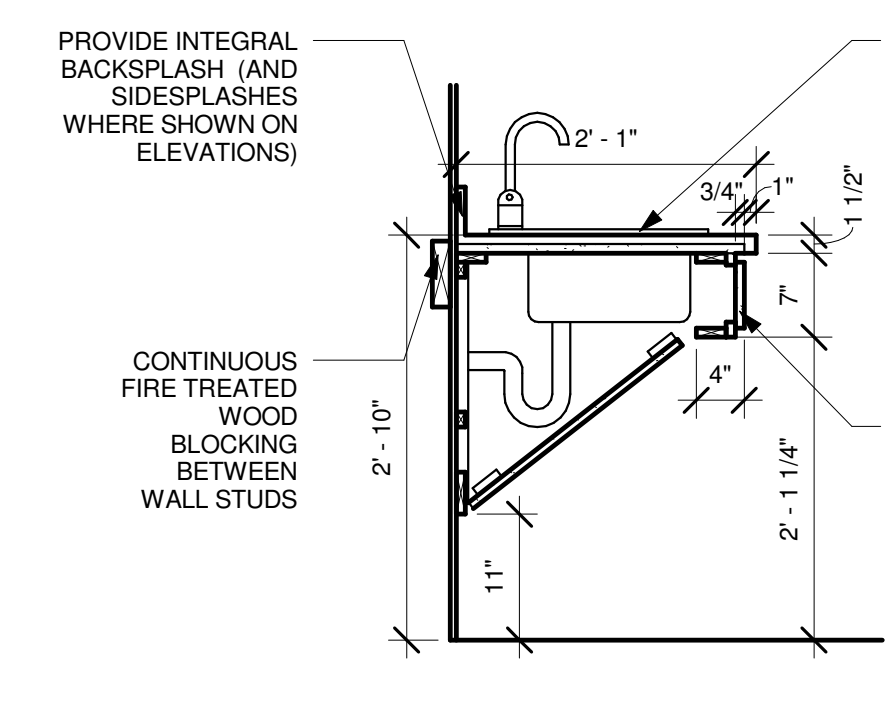6 BASE CABINET W/ 4 DRAWER - TYPICAL
SCALE: 3/4\" = 1'-0\"



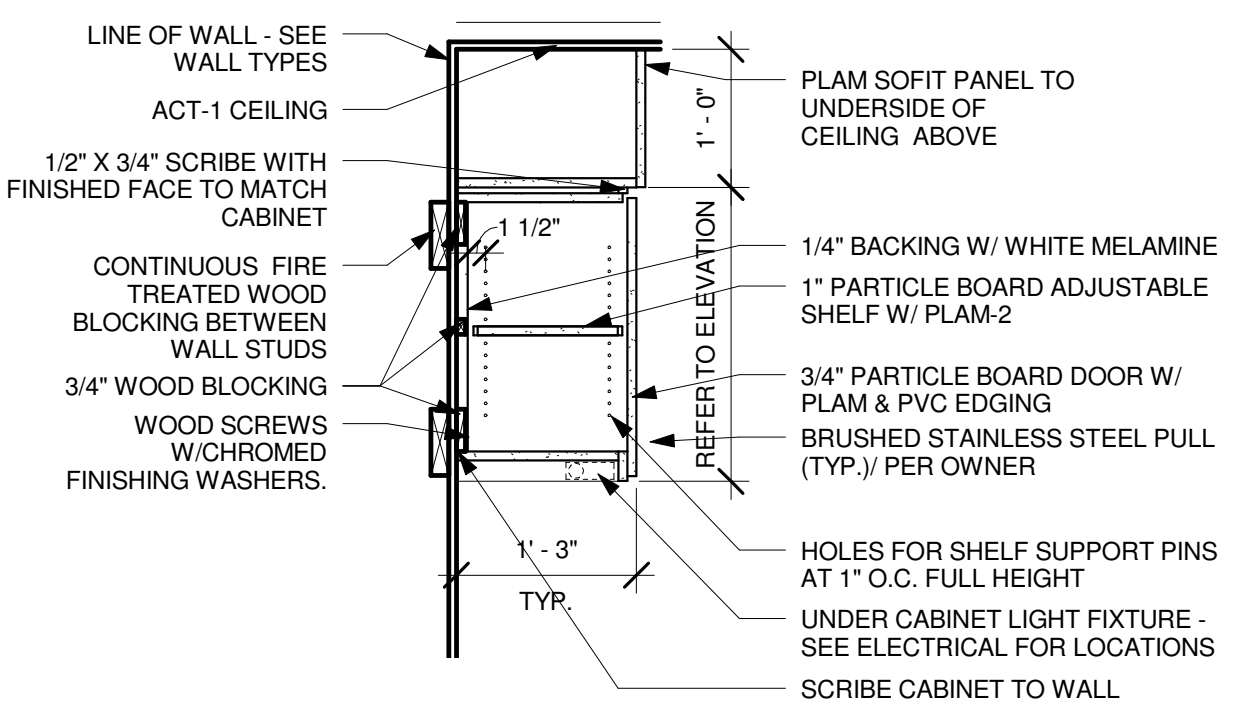7 BASE CABINET W/ ADA SINK - TYPICAL
SCALE: 3/4\" = 1'-0\"
RE:1 /1-AS701





8 UPPER CABINET W/ DOOR - TYPICAL
SCALE: 3/4\" = 1'-0\"

SHEET NOTES

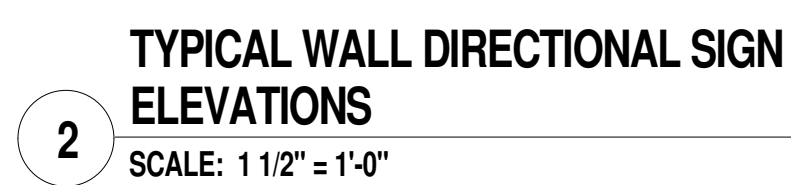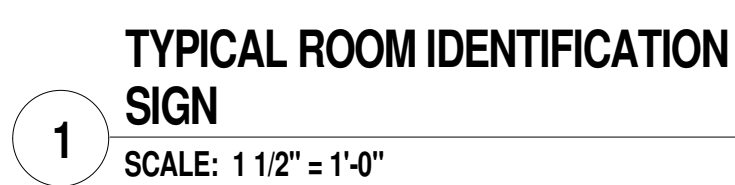- A ALL MILLWORK TO USE PLASTIC LAMINATE
- B PLASTIC LAMINATE TO MEET NEMA LD-3 STANDARDS
- C EXPOSED DECORATIVE SURFACES INCLUDING BOTH SIDES AND EDGES OF CABINET DOORS SHALL BE FURNISHED IN (PLAM-1)
- D CABINET INTERIORS INCLUDING SHELVING SHALL BE FURNISHED IN (PLAM)
- E USE PLASTIC LAMINATE CLAD PARTICLE BOARD FOR ALL MILLWORK
- F PARTICLEBOARD TO COMPLY WITH CPA A208.1, TYPE 1, GRADE 1-M-3
- G PROVIDE RUBBER BASE OVER MILLWORK KICKPLATE, SEE ROOM FINISH SCHEDULE
- H EACH DOOR SHALL HAVE TWO DOOR HINGES WITH A MINIMUM THICKNESS OF 2MM. DOORS SHALL CLOSE AGAINST TWO RUBBER BUMPERS.
- I HINGES SHALL BE FIVE KNUCKEL W/ HOSPITAL TYPE TIPS.
- J FRICTION OR MAGNETIC TYPE DOOR CATCHES, FABRICATED WITH METAL HOUSING
- K DOORS AND DRAWERS SHALL HAVE STAINLESS STEEL PULLS, EQUIVALENT TO HAFELE
- L DRAWER SLIDES SHALL BE FULL EXTENSION STEEL SLIDES WITH NYLON BALL-BEARING ROLLERS WITH A POSITIVE STOP
- M PROVIDE 18 GAGE STAINLESS STEEL SLOPING TOPS FOR MILLWORK
- N WHERE SOLID SURFACE COUNTER TOP, SIDE SPLASH, AND BACK SPLASH ARE CALLED FOR USE (SSCT-1)
- O SUBMIT COMPLETE SHOP DRAWINGS AND MATERIAL SAMPLES FOR REVIEW

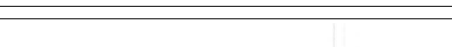

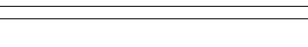
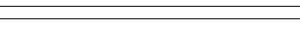
BUILDING IS FULLY SPRINKLERED

Revisions:	Date	12 APRIL 2013	CONSULTANTS: IEA 9201 West Broadway Brooklyn Park, MN 55445 Tel: 763.315.7600 Fax: 763.315.7920	SSR Smith Stockman Reid, Inc. 8055 E. Taffin Ave. Suite 1100 Denver, CO 80231 (303) 778-1223 FAX: (303) 694-9144 www.ssr-inc.com	ARCHITECT/ENGINEERS: COX DESIGN ASSOCIATES ARCHITECTURE PLANNING INTERIORS Austin 5121 Bee Caves Road, Suite 203 Austin, Texas 78746 T:512 - 327 - 4149 F:512 - 327 - 7679 coxdesign@austin.rr.com Chicago 345 N. Canal St. Suite 701 Chicago, IL 60605 T:312 - 454 - 9434 F:312 - 454 - 9439 bcox@coxtd.com	Approved: Medical Center Director Approved: Associate Director Approved: Chief, Facility Mgmt	Approved: Safety Officer Approved: Chief, IT Approved: Service Chief	Approved: Chief, EMS Approved: Chief, Infection Control Approved: Chief, Police	Drawing Title MILLWORK Location GRAND JUNCTION VAMC 2121 NORTH AVENUE GRAND JUNCTION, CO 81501	Project Name RENOVATE 6TH FLOOR Building Number 1	Project Number 575-12-102 Date 12 APRIL 2013 Drawing Number 1-AS701 Dwg. of	Office of Construction and Facilities Management Department of Veterans Affairs
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A. COORDINATE ALL WAYFINDING WITH:
CREATIVE SIGNAGE SYSTEMS
9101 51ST PLACE
COLLEGE PARK, MD 20746

**BUILDING IS
FULLY
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